General Notes (NCC 2019 BCA Vol 2)

- I. All materials and work practices shall comply with, but not limited to the Building Regulations 2018, National Construction Code Series 2019 Building Code of Australia Vol 2 and all relevant current Australian Standards (as amended) referred to therein.
- 2. Unless otherwise specified, the term BCA shall refer to National Construction Code Series 2019 Building Code of Australia Volume 12. Concrete stumps:
- 3.All materials and construction practice shall meet the Performance Requirements of the BCA. Where a performance solution is proposed then, prior to implementation or installation, it first must be assessed and approved by the Relevant Building Surveyor as meeting the Performance Requirements of the BCA.
- 4. Glazing, including safety glazing, shall be installed to a size, type and thickness so as to comply with:
- -- BCA Part 3.6 for Class I and IO Buildings within a design wind speed of not more than N3; and
- -- BCA Vol | Part B1.4 for Class 2 and 9 Buildings.
- 5. Waterproofing of wet areas, being bathrooms, showers, shower rooms, laundries, sanitary compartments and the like shall be provided in accordance with AS 3740-2010: Waterproofing of Domestic Wet Areas.
- 6. These Drawings shall be read in conjunction with any House Energy Rating (HERS) report and shall be constructed in accordance with the stamped plans endorsed by the accredited Thermal Performance Assessor without alteration.
- 7. Step sizes (other than for spiral stairs) to be:
 - > Risers (R) 190mm maximum and 115mm minimum
 - > Going (G) 355mm maximum and 240mm minimum
 - \rightarrow 2R + 1G = 700mm maximum and 550mm minimum
 - > with less than 125mm gap between open treads.
- 8.All treads, landings and the like to have a slip-resistance classification of P3 or R10 for dry surface conditions and P4 or R11 for wet surface conditions, or a nosing strip with a slip-resistance classification of P3 for dry surface conditions and P4 for wet surface conditions.
- 9. Provide barriers where change in level exceeds 1000mm above the surface beneath landings, ramps and/or treads. Barriers (other than tensioned wire barriers) to be:
 - > 1000mm min. above finished surface level of balconies, landings or the like and
 - > 865mm min. above finished surface level of stair nosing or ramp,
 - > vertical with less than 125mm gap between, and
 - > any horizontal element within the barrier between 150mm and 760mm above the floor must not facilitate climbing where changes in level exceeds 4000mm above the surface beneath landings, ramps and/or treads.
 - > Wire barrier construction to comply with NCC 2019 BCA Part 3.9.2.3 for Class I and IO Buildings and NCC 2019 BCA Volume | Part D2.16 for other Classes of Buildings.
- 10. Top of hand rails to be minimum 865mm vertically above stair nosing and floor surface of ramps

II. Window sizes nominated are nominal only. Actual size may vary according to manufacturer. Windows to be flashed all around.

Where the building (excludes a detached Class 10) is located in a termite prone area the building is to be provided with a termite management system.

- > up to 1400mm long to be 100mm x 100mm (1 No. H.D. Wire)
- > 1401mm to 1800mm long to be 100mm x 100mm (2 No. H.D.
- \rightarrow 1801mm to 3000mm long to be 125mm x 125mm (2 No. H.D. Wires)
- > 100mm x 100mm stumps exceeding 1200mm above ground level to be braced where no perimeter base brickwork provided.
- 13. Buildings in marine or other exposure environments shall have masonry units, mortar and all built in components and the like complying with the durability requirements of Table 4.1 of AS 4773.1-2015 'Masonry in small buildings' Part 1: Design.
- 14. All stormwater to be taken to the legal point of discharge to the Relevant Authorities approval.
- 15. These drawings shall be read in conjunction with all relevant structural and all other consultants' drawings/ details and with any other written instructions issued in the course of the contract.
- 16. Site plan measurements in metres all other measurements in millimetres unless noted otherwise
- 17. Figured dimensions take precedence over scaled dimensions.
- 18. The Builder shall take all steps necessary to ensure the stability and general water tightness of all new and/or existing 28. structures during all works.
- 19. The Builder and Subcontractors shall check and verify all dimensions, setbacks, levels and specifications and all other relevant documentation prior to the commencement of any works. Report all discrepancies to this office for clarification.
- Installation of all services shall comply with the respective supply authority requirements.
- The Builder and Subcontractor shall ensure that all stormwater drains, sewer pipes and the like are located at a sufficient distance from any buildings footing and/ or slab edge beams so as to prevent general moisture penetration, dampness, weakening and undermining of any building and its footing system.
- These plans have been prepared for the exclusive use by the Client of [Insert Drafting Service] ('The Designer') for the purpose expressly notified to the Designer. Any other person who uses or relies on these plans without the Designer's written consent does so at their own risk and no responsibility is accepted by the Designer for such use and/or reliance.
- A building Permit is required prior to the commencement of these works. The release of these documents is conditional to the Owner obtaining the required Building Permit.
- The Client and/or the Client's Builder shall not modify or amend the plans without the knowledge and consent of [building

designer's name] except where a Registered Building Surveyor makes minor necessary changes to facilitate the Building Permit application and that such changes are promptly reported back to [building designer's name].

- The approval by this office of a substitute material, work practice, variation or the like is not an authorisation for its use or a contract variation. All variations must be accepted by all parties to the agreement and where applicable the Relevant Building Surveyor prior to implementing any variation.
- STORMWATER 100 mm DIA. Class 6 UPVC stormwater line laid to a minimum grade of 1:100 and connected to the legal point of stormwater discharge. Provide inspection openings at 9000mm C/C and at each change of direction.
- > The cover to underground stormwater drains shall be not less
- > 100mm under soil
- ! 50mm under paved or concrete areas
- 100mm under unreinforced concrete or paved driveways
- ! 75mm under reinforced concrete driveways
- SITE ENVIRONMENT DESIGN INFORMATION (if applicable)
 - > Site Bushfire Attack Assessment (simplified method)
 - 1.Reference document 'AS 3959-2009 construction of buildings in bush fire prone areas'
 - Relevant Fire Danger Index (FDI)-
 - Predominate vegetation:- Classification
 - Type
 - Distance of site from predominate vegetation-
 - Effective slope of land-
 - vii. Determination of Bushfire attack Level (BAL)-
- Site Classification (if Applicable)
- > Site classification as Class:
- > Refer to soil report No:
- > By:
- Design Gust Wind Speed / Wind Classification
- > Building tie-downs to be provided in accordance with AS 1684-2010 for an assumed design gust wind speed / wind classification of N1/N2 (subject to confirmation on site by Relevant Building Surveyor at first inspection) refer to AS I 684 for construction requirements.
- Climate Zone Climate zone for thermal design / thermal performance assessment: Zone 6 \$ 7
- Corrosion protection of built-in structural members
 - > Provide corrosion protection of built-in structural steel members such as steel lintels, shelf angles, connectors, accessories (other than wall ties) in accordance with Table 4.1 of AS4773.1-2015 Masonry in Small Buildings, Part 1: Design suitable for an Environment Classification of [Insert environment classification]
- Corrosion protection for sheet roofing
- Provide corrosion protection for sheet roofing in accordance with BCA Table 3.5.1.

34. ENERGY RATING:

THERMAL INSULATION TO BE PROVIDED AS FOLLOWS:

SEE 6 STAR REQUIREMENTS/NOTES OR ENERGY EFFICIENCY

- 35. Compliance with AS3700 and AS4773 -2018
- 36. Pliable Building Membrane to comply with AS4200.1, AS4200.2 and Clause 3.8.7.2,
- 37. Flashing to comply with Clause 3.5.2.3
- 38. Tiles to overhang the fascialtiling batten by not less than 35mm
- 38. Sarking requirements as per Clause 3.5.24 of NCC 2019: ADDITIONALLY, NOMINATE TABLE 3.5.2.2 and the flammability index of not more than 5 for the sarking material

WRITTEN DIMENSIONS TAKE PRECEDENCE OVER SCALE, ELOOR

WINDOWS U.N.O.

PLAN DIMENSIONS ARE TO FRAME SIZE ONLY. WINDOW SIZES SHOWN ARE SUPPLIERS FRAME SIZES. ALL GLAZING TO COMPLY WITH A.S. 1288 & AS 2047 GLASS IN BUILDINGS, & WITH A.S. 4055-1992 FOR WINDLOADING. WINDOW SUPPLIER TO PROVIDE COVER BOARDS TO ALL CORNER

GARAGE ROOF TO BE TIED DOWN MIN. 1200 INTO BRICKWORK WITH HOOP IRON STRAPS.

ALL WATER CLOSET DOORS TO BE REMOVABLE IN ACCORDANCE WITH B.C.A.3.8.3.



your dream home builder

JOB NUMBER: OOO I SHEET NUMBER ► SHEET CONTENT SCALE: AS SHOWN 1 OF 8 GENERAL NOTES 29.03.23 DRAWN: BOH PROPERTY ADDRESS: HOUSE - 6 SSUE: DATE: DETAILS: INITIALS LOT 20110 LASIO WAY. A 29.03.23 WORKING DRAWING вон '| DONNYBROOK, VIC, 3064. B 06.04.23 WORKING DRAWING REV-I BOH 16.06.23 WORKING DRAWING REV-2 вон WORKING DRAWING

NOTE: ROOF DESIGN SHOWN FOR GUIDE PURPODES ONLY, SEE

THE ROOF MANUFACTURES DRAWINGS FOR EXACT DESIGN

NOTE:

DRAINAGE GUIDE SHOWN IS FOR ROOF DRAINAGE ONLY, ALI SITE DRAINAGE AS PER PLUMBER & BUILDERS DESIGN. BUILDING SURVEYOR O CONFIRM.

NOTE:

SITE SCRAPE BUILDING AREA TO REMOVE EXCESS VEGETATION ¢ PROVIDE LEVEL BUILDING PLATFORM BUILDER TO VERIFY

LANDSCAPING:

ANDSCAPING TO COMPLY WITH COMPLETED BY CLIENT AFTER **HANDOVER**

NOTE:

GROUND LEVEL

NOTE:

IDE .REAR & WING FENCE TO BE

JIDELINES REQUIREMENTS \$

PRIVEWAY & FRONT PATH TO BE

ONSTRUCTED OF EXPOSED

GGREGATE. DRIVEWAY TO BE

OMPLY WITH RELEVANT DESIGN

SIDE GATE MUST COMPLEMENT THE

ARCHITECTURAL CHARACTER OF THE

DWELLING & MUST NOT BE HIGHER

THAN I.8M ABOVE THE NATURAL

COMPLETED BY BUILDER & TO

OMPLETED BY BUILDER

ONSTRUCTED AS PER DEVELOPERS

DRIVE WAY TO BE GRADED TO ENSUR DEVELOPER GUIDELINES \$ TO BE MAXIMUM 1:6 GRADIENT FROM CROSSOVER TO GARAGE FLOOR

NOTE:

CONCRETER/BUILDER TO MAKE SURE THAT A MIN 385MM TO BE EXCAVATED BELOW FLOOR LEVEL IN RESIDENCE & GARAGE FOR A WAFFLE SLAB. CHECK ON SITE BEFORE COMMENCING

LEVELS:

ALL LEVEL & FINISHED FLOOR LEVELS AREA TAKEN FROM ENGINEERING PLAN PROVIDED BY THE COUNCIL STOMWATER NFORMATION CERTIFICATE. BUILDER IS TO VERIFY ON SITE ALL LEVELS PRIOR TO THE COMMENCEMENT OF ANY BUILDING WORKS. NEW LEVELS SHOULD BE DONE TO DETERMINE NEW SITE CONDITIONS

STROMWATER POINT:

STORMWATER POINT TO BE VERIFIED ON SITE PRIOR TO THE COMMENCMENT OF ANY BUILDING WORKS. STORMWATER LAYOUT AS PER PLUMBERS \$ BUILDERS DESIGN \$ TO BE CONFIRMED ON SITE BY THE PLUMBER & BUILDER

ALL SURROUNDING SURFACES ARE TO BE GRADED AWAY FROM THE BUILDING TOWARDS A SUITABLE DRAINAGE FACILITY. TO AVOID ANY LOCAL DAMMING OR PONDING BUILDING SURVEYOR IS TO CHECK AND VERIFY THAT NO SERVICES ARE PLACED WITHIN 45 ANGLE OF REPOSE TO PROPERTY FOOTINGS. NEW FOOTINGS ARE NOT UNDERMINE EXISTING FOOTINGS AND ARE TO MATCH THE DEPTH OF THE EXISTING FOOTINGS, WHERE APPROPRIATE.

INSTALL SURFACE SPOON DRAINS AND CUT - OFF DRAINS UP SLOPE OF THE BUILDING SITE TO INTERCEPT AND CHANNEL BOTH RUN - OFF AND SHALLOW GROUNDWATER SEEPAGE AWAY FORM THE SITE CUTS AND FOUNDATIONS. CUT OFF DRAINS SHOULD PENETRATE 50mm BELLOW THE UPPER CLAY SURFACE. BUILDER TO BE VERIFY ON SITE PRIOR TO THE COMMENCEMENT OF ANY BUILDING WORKS

NOTE:

ALL CUT AND FILL SHOULD BE BATTERED OR RETAINED PROPERLY AS A GENERAL RULE, BATTERS OF 45 DEGREES TO THE HORIZONTAL FOR CLAYS AND 30 DEGREES TO THE HORIZONTAL FOR SANDS SHOULD BE ADOPTED. WHERE THIS IS NOT POSSIBLE OR DESIRED ENGINEER DESIGNED RETAINING WALLS SHOULD BE USED. WHERE SITES ARE PRONE TO LANDSLIPS, A LANDSLIP ASSESSMENT SHOULD BE CARRIED

NOTE:

COMPLETE ACCURACY OF THIS PLAN IS NOT GUARANTEED DETAILS SHOWN SHOULD BE CHECKED AND PROVED ON SITE BEFORE ANY WORK IS CARRIED OUT.

ALL UTILITY AUTHORITIES SHOULD BE CONTACTED REGARDING THE EXISTENCE OF ANY UNDERGROUND SERVICE ON SITE AND SURROUNDING THE SITE

NOTE:

RIVE WAY TO BE GRADED TO SURE MAXIMUM 1:6 GRADIEN ROM CROSSOVER TO SARAGE FLOOR

ANDSCAPING:

DEVELOPER GUIDELINES \$ TO BE COMPLETED BY CLIENT AFTER HANDOVFR

SCO

HOUSE UNDER

CONSTRUCTION

DOUBLE STOREY

EAVES HT 106.82

RIDGE HT 108.80

HOUSE UNDER

CONSTRUCTION

SINGLE STOREY

EAVES HT 103.97

RIDGE HT 105.72

HOUSE UNDER

CONSTRUCTION

SINGLE STOREY

EAVES HT 104.10

RIDGE HT 106 26

ERMITE NOTE:

ISK OF TERMITE ATTACK TO PRIMARY BUILDING ELEMENTS IN ACCORDANCE WITH AS3660. I A DURABLE NOTICE MUST BE PERMANENTLY FIXED TO THE BUILDING IN PERMANENT LOCATION, INDICATING

TERMITE BARRIER TO BE INSTALLED TO MINIMISE T

- HE FOLLOWING THE METHOD OF TERMITE RISK MANAGEMENT
- THE DATE OF INSTALLATION OF THE SYSTEM WHERE CHEMICAL BARRIER IS USED ITS LIFE EXPECTANCY AS LISTED ON THE NATIONAL
 - REGISTRATION AUTHORITY LABEL THE INSTALLER'S OR MANUFACTURER'S RECOMMENDATIONS FOR THE SCOPE \$ FREQUENCY OF FUTURE

INSPECTIONS FOR TERMITE ACTIVITY

EASEMENT 2.0m

300¢

NOTE:

PRIVATE OPEN

SPACE 37.92 SQ.M

3980

WALL ON BOUNDARY

FFL: 100.585

CONSTRUCTED OF 1.8M HIGH

PRE-COATED METAL SHEETING

OR COLOURED TO MATCH

PANELS IN 'GREY RIDGE' COLOUR

/ WAFFLE- SLAB

385mm FREEBOARD

RECYCLED WATER TO BE CONNECTED AND INSTALLED IN ACCORDANCE WITH THE RECYCLED WATER PLUMBING GUIDE, ISSUED BY THE PLUMBING COMMISSION

AS/NZS 3500 Plumbing Regulations

RECYCLED WATER MUST BE CONNECTED TO THE DWELLING AS PER DEVELOPERS GUIDELINES:

- RECYCLED WATER RUN IN
- CONNECTION OF RECYCLED WATER TO ALL APPLICABLE TOILET SUITES

VAPOUR PERMEABLE MEMBRANE MUST

OF THE PRIMARY INSULATION LAYER OF

EXTERNAL ENVELOPE OF A BUILDING IN

INSTANTANEOUS

HOT WATER

PROPOSED

RESIDENCE

LOT 20110

VACANT AS OF

6° 30' 50"

LOT 20111

VACANT AS OF 14/06/2023

BE INSTALLED ON THE EXTERIOR SIDE

WALL ASSEMBLIES THAT FORM THE

ACCORDANCE WITH BCA 3.8.7.2

I X RECYCLED WATER TAP TO REAR OF DWELLING I X RECYCLED WATER CONNECTION TO LAUNDRY

NATIONAL BROADBAND NETWORKCO:

SMALL LOT TYPE A

TBM TOP OF ELECTRICITY PIT

CONNECT SWD TO

-ASIO WAY

LEGAL POINT OF DISCHARGE

IN ACCORDANCE WITH THE

LOCAL AUTHORITIES POLICY

3000

5000

NBN

GARAGE SETOUT

EXPOSED AGGREGATE TO

FRONT PATH (25.7 SQM.)

DRIVEWAY PORCH AND

HIS IS A FIBRE OPTIC ESTATE: BROADBAND LEAD -IN CONDUIT IN ACCORDANCE WITH VBN CO.REQUIREMENTS.

SOIL CLASSIFICATION: "P"

. 238651 IOB NO

GARAGE FAVES WITHIN 450mm OF

9670

WALL ON BOUNDARY

FFX: 100.415

∕GARAGE`

6470

WALL ON BOUNDARY

0 \(\)

LOT 20109

VACANT AS OF 14/06/2023


THE TITLE BOUNDARY MUST HAVE A

6mm FYRCHEK TO THE UNDERSIDE OF

THE EAVE \$ TO THE SIDE FACEBORD TO

ACHIEVE FIRE RATING WITH FRL OF 60/60/60

GEOHUB GEOTECHNICAL : 14/06/2023

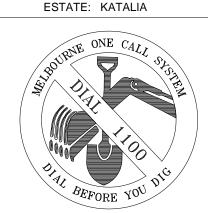

SITE PARTICULARS

2.0M EASEMENT TO REAR

ADJOINING PROPERTIES

CROSSOVER LOCATIONS R/H SIDE

BUILDING ENVELOPE ON PROPERTY

BUSHFIRE CONSTRUCTION PROPERTY

TERMITE CONSTRUCTION PROPERTY

YES

、/

NO

/

/

NOTE:

ALL SURFACES AROUND THE HOUSE NEEDS TO BE SLOPED

NOTE:

EMPORARY DOWN PIPES URING CONSTRUCTION ONNECTION TO UNDERGROUNI TORM WATER SYSTEM

STORM WATER DRAINAGE

EAVES WITHIN 450mm OF THE ALLOTMENT BOUNDARY MUST ACHIEVE AN FRL OF 60/60/60

LAND SIZE FALLS B/W 400-500M IN ACCORDANCE WITH REGULATION 76A OF BUILDING 2018.

SITE AREA SITE COVERAGE

30.00

192.63 m²

294 m²

65.52 %

SITE PLAN

WRITTEN DIMENSIONS TAKE PRECEDENCE OVER SCALE. FLOOR PLAN DIMENSIONS ARE TO FRAME SIZE ONLY WINDOW SIZES SHOWN ARE SUPPLIERS FRAME SIZES.

ALL GLAZING TO COMPLY WITH A.S. 1288 & AS 2047 GLASS IN BUILDINGS, & WITH A.S. 4055-1992 FOR WINDLOADING WINDOW SUPPLIER TO PROVIDE COVER BOARDS TO ALL CORNER

WINDOWS U.N.O. GARAGE ROOF TO BE TIED DOWN MIN. 1200 INTO BRICKWORK WITH HOOP IRON STRAPS

ALL WATER CLOSET DOORS TO BE REMOVABLE IN ACCORDANCE WITH B.C.A.3.8.3



High your dream home builder

JOB NUMBER: OOO I ► SHEET CONTENT: SCALE: 1:200 2 OF 8 SITE PLAN DATF: 29.03.23 DRAWN: PROPERTY ADDRESS: HOUSE - 6 SSUF! DATE: DETAILS VITIALS LOT 20110 LASIO WAY. A 29.03.23 WORKING DRAWING BOH DONNYBROOK, VIC, 3064. B 06.04.23 WORKING DRAWING REVвон WORKING DRAWING REV-2 вон WORKING DRAWING


SHALL COMPLY WITH 53500.3-2015 NOTE: THERE IS NO WALL MOUNTED AIR CONDITIONING UNIT NOTE: ROOF STORMWATER TO BE ACCORANCE WITH AS 3500 90mm DIA DOWNPIPES NOTE: MINIMUM GARDEN AREA OF 25% AS

TOTAL HOUSE AREA

TOTAL HOUSE AREA **PAVING**

PERMEABLE COVERAGE

24.28 %

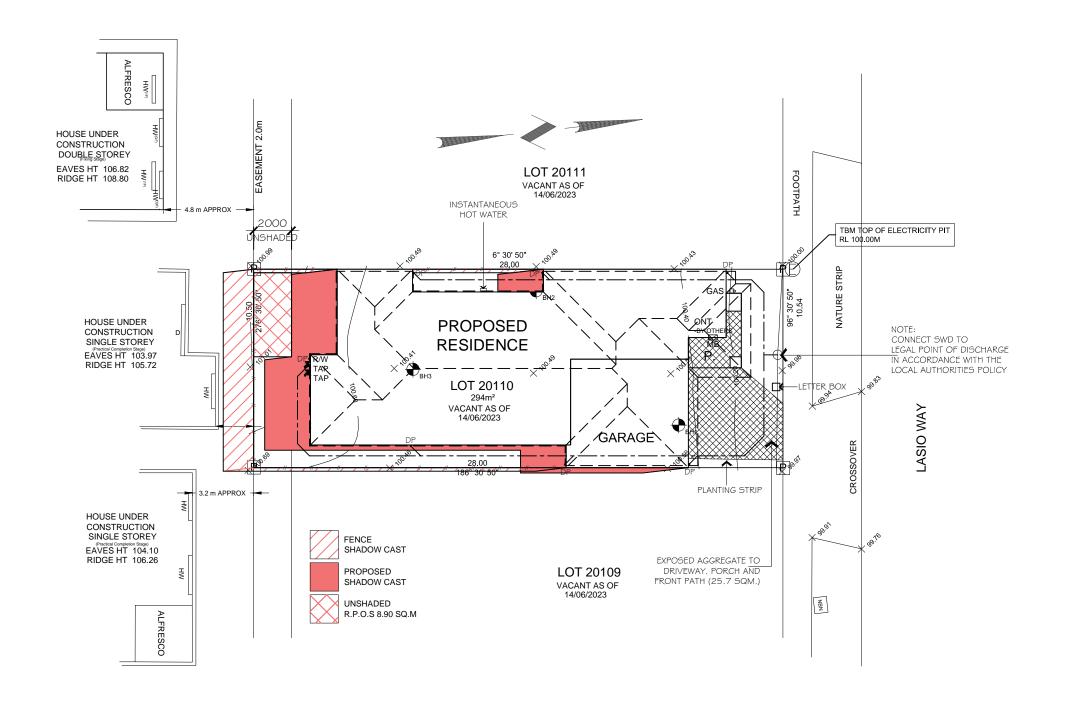

OVERSHADOWING 12.0PM

WRITTEN DIMENSIONS TAKE PRECEDENCE OVER SCALE. FLOOR PLAN DIMENSIONS ARE TO FRAME SIZE ONLY.

WINDOW SIZES SHOWN ARE SUPPLIERS FRAME SIZES. ALL GLAZING TO COMPLY WITH A.S. 1288 & AS 2047 GLASS IN BUILDINGS, & WITH A.S. 4055-1992 FOR WINDLOADING.

WINDOW SUPPLIER TO PROVIDE COVER BOARDS TO ALL CORNER WINDOWS U.N.O.

GARAGE ROOF TO BE TIED DOWN MIN. 1200 INTO BRICKWORK WITH HOOP IRON STRAPS.

ALL WATER CLOSET DOORS TO BE REMOVABLE IN ACCORDANCE WITH B.C.A.3.8.3



					PER	RMEABLE	COVERAGE	24.28	8 %
_	SHEET CONTENT:	SC	ALE:	:200)	SHEET NU 2A 0		JOB NUMBER:	0001
K	HADOWING PLAN- I 2PM PROPERTY ADDRESS: HOUSE - G	DA	TE:	29.0	3.23	DRAWN:	вон		
Ц			ISSUE:	DATE	:	DETAILS:			INITIALS:
_	LOT 20110 LASIO WAY,		Α	29.03	3.23	WORKING DRA	AWING		вон
•	DONNYBROOK, VIC, 3064.	١.,	В	06.04	4.23	WORKING DRA	AWING REV-I		вон
C	CLIENT:	S	С	16.06	.23	WORKING DRA	AWING REV-2		вон
	xxx	ō							
Z	^^^	<u>0</u>							
		\leq							
_	WORKING DRAWING	R							
	WORKING DIV WING								

TOTAL HOUSE AREA

192.63 m²

65.52 %

30.00


294 m²

TOTAL HOUSE AREA

SITE COVERAGE

SITE AREA

PAVING

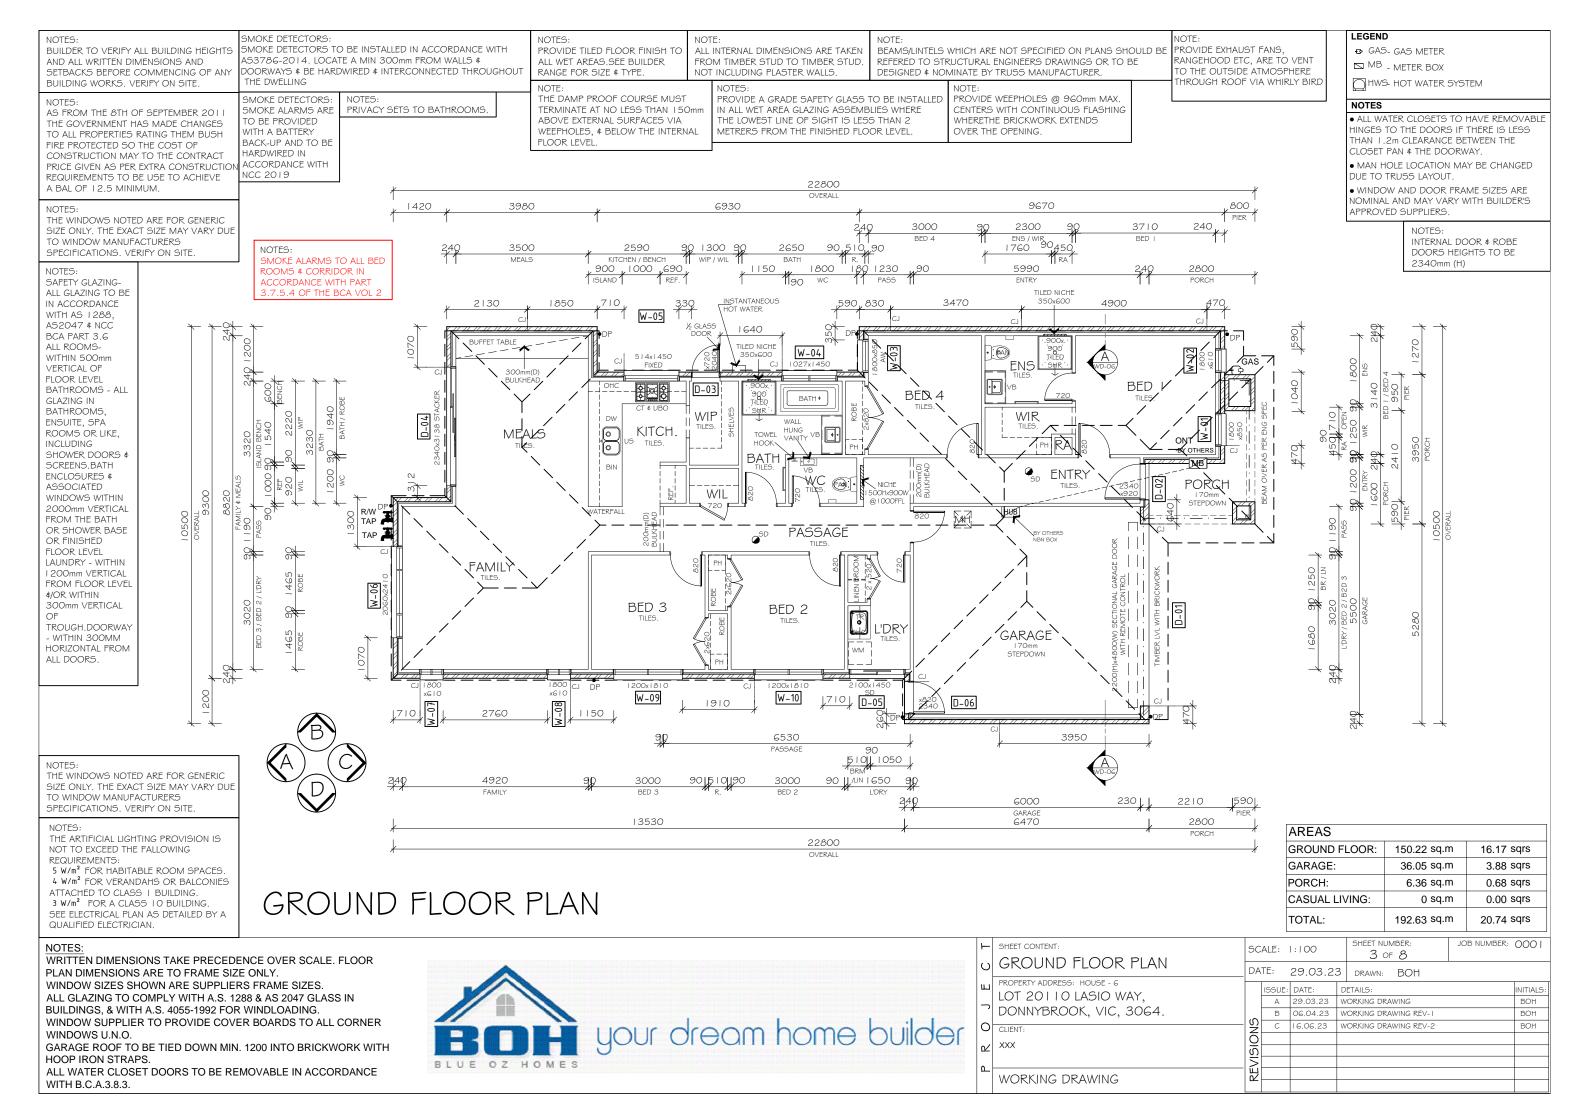

IT IS BUILDER RESPONSIBILITY TO ESTABLISH THE FINISHED FLOOR LEVELS & FINISHED WALL HEIGHTS IN RELATION TO

THE RELEVANT GROUND LEVELS DURING SETOUT \$ BEFORE ANY EXCAVATION WORKS ARE UNDERTAKEN SO AS TO ENSURE THAT ALL DESIGN ASSUMPTIONS ARE FULLY REALIZE IN PRACTICE & COMPLY WITH THE RELEVANT BUILDING CODES & SITTING REQUIREMENTS.

NOTE

USUALLY A SECTIONAL DETAIL IS SHOWN, SHOWING THE DAMP PROOF COURSE TERMINATING BELOW THE INTERNAL FLOOR LEVEL, AND A MIN LOOMM ABOVE EXTERNAL SURFACE. ALSO THIS SECTION WOULD HAVE A NOTE STATING "SURFACE AROUND THE PERIMETER OF DWELLING TO BE GRADED AWAY AT 25MM OVER THE FIRST METRE". THIS SAVE A HEAP OF HEADACHES AT THE END OF THE JOB, WHERE THE WEEP HOLES DON'T HAVE ENOUGH CLEARING. AND THE SURFACE AROUND THE DWELLING HAS NO FALL.

NOTE:

PROVIDE WEEPHOLES @ 960mm MAX. CENTERS WITH CONTINUOUS FLASHING WHERE THE BRICKWORK EXTENDS OVER THE OPENING

WEEP HOLES @ 1.2 METRE SPACING AND ABOVE WINDOWS MORE THAN I.O METRE WIDF

NOTE:


ROOF DESIGN SHOWN FOR GUIDE PURPOSES ONLY, SEE THE ROOF MANUFACTURES DRAWINGS FOR EXACT DESIGN.


PLATFORMS OUTSIDE EXTERNAL DOORS BACKFILL TO DOORS NOT TO BE GREATER THAN 190mm IN ACCORDANCE WITH BCA 3.9.1.5 THRESHOLDS.

NOTE:

WHERE CONSTRUCTION JOINTS ARE ADJACENT TO A DOOR OR OPENING, THE ARTICULATION JOINTS ARE TO EXTEND ALONGSIDE THE OPENING.


STEP DOWN NOT EXCEED 230mm FOR (L'DRY DOOR, REAR SLIDING DOOR & FRONT DOOR)

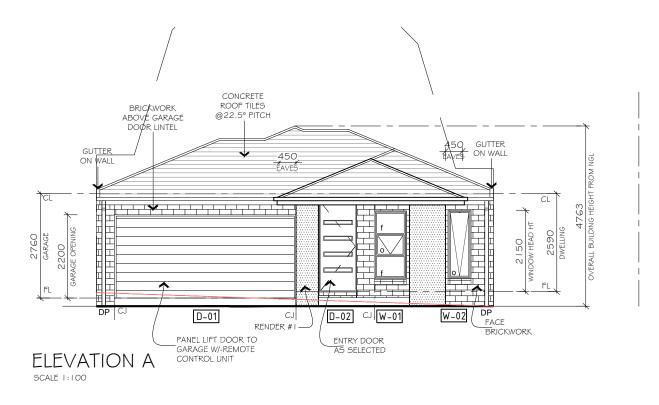

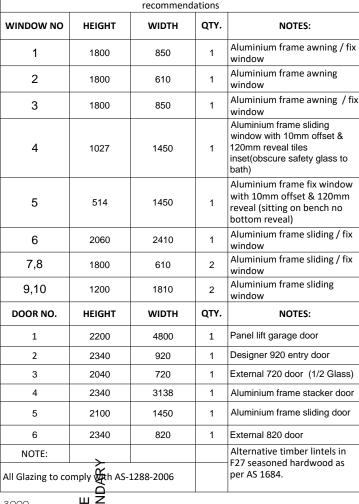

WINDOW & DOOR SCHEDULE

All lintel sizes to be checked and compared with engineer's specifications/size

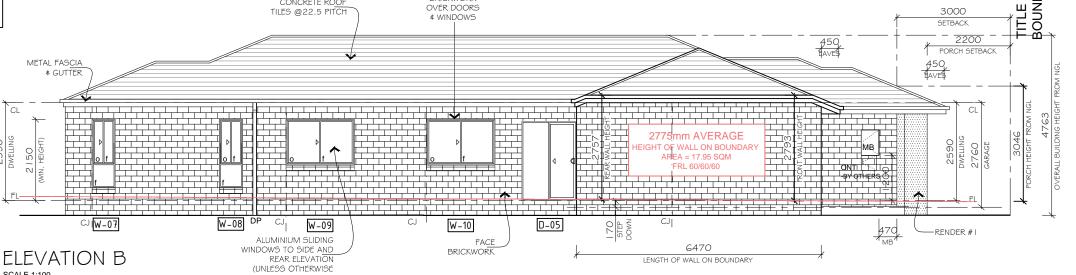

ELEVATIONS

WRITTEN DIMENSIONS TAKE PRECEDENCE OVER SCALE, FLOOR PLAN DIMENSIONS ARE TO FRAME SIZE ONLY

WINDOW SIZES SHOWN ARE SUPPLIERS FRAME SIZES. ALL GLAZING TO COMPLY WITH A.S. 1288 & AS 2047 GLASS IN BUILDINGS, & WITH A.S. 4055-1992 FOR WINDLOADING.

WINDOW SUPPLIER TO PROVIDE COVER BOARDS TO ALL CORNER WINDOWS U.N.O.

GARAGE ROOF TO BE TIED DOWN MIN. 1200 INTO BRICKWORK WITH HOOP IRON STRAPS.

ALL WATER CLOSET DOORS TO BE REMOVABLE IN ACCORDANCE WITH B.C.A.3.8.3



BRICKWORK

CONCRETE ROOF

-	SHEET CONTENT:	SC	ALE:	1:100	SHEET NUMBER: 4 OF 8	JOB NUMBER:	0001
O	ELEVATIONS: A & B	DA	TE:	29.03.23	BOH		
ш	PROPERTY ADDRESS: HOUSE - 6		ISSUE:	DATE:	DETAILS:		INITIALS:
۱_	LOT 20110 LASIO WAY, DONNYBROOK, VIC, 3064.		A	29.03.23	WORKING DRAWING		BOH
,			В	06.04.23	WORKING DRAWING REV-I		вон
0	CLIENT:	18	С	16.06.23	WORKING DRAWING REV-2		ВОН
o∠	xxx	000					
		=					
_ □	WORKING DRAWING	RE					

IT IS BUILDER RESPONSIBILITY TO ESTABLISH THE FINISHED FLOOR LEVELS & FINISHED WALL HEIGHTS IN RELATION TO THE RELEVANT GROUND LEVELS DURING SETOUT \$ BEFORE ANY EXCAVATION WORKS ARE UNDERTAKEN SO AS TO ENSURE THAT ALL DESIGN ASSUMPTIONS ARE FULLY REALIZE IN PRACTICE & COMPLY WITH THE RELEVANT BUILDING CODES \$ SITTING REQUIREMENTS.

NOTE: USUALLY A SECTIONAL DETAIL IS SHOWN, SHOWING THE DAMP PROOF COURSE TERMINATING BELOW THE INTERNAL FLOOR LEVEL, AND A MIN TOOMM ABOVE EXTERNAL SURFACE. ALSO THIS SECTION WOULD HAVE A NOTE STATING "SURFACE AROUND THE PERIMETER OF DWELLING TO BE GRADED AWAY AT 25MM OVER THE FIRST METRE". THIS SAVE A HEAP OF HEADACHES AT THE END OF THE JOB, WHERE THE WEEP HOLES DON'T HAVE ENOUGH CLEARING, AND THE SURFACE AROUND THE DWELLING HAS NO FALL.

NOTE:

PROVIDE WEEPHOLES @ 960mm MAX.
CENTERS WITH CONTINUOUS FLASHING WHERE THE BRICKWORK EXTENDS OVER THE OPENING

WEEP HOLES @ 1.2 METRE SPACING AND ABOVE WINDOWS MORE THAN I.O METRE WIDE.

NOTE:

ROOF DESIGN SHOWN FOR GUIDE PURPOSES ONLY, SEE THE ROOF MANUFACTURES DRAWINGS FOR EXACT DESIGN.


NOTE:


PLATFORMS OUTSIDE EXTERNAL DOORS BACKFILL TO DOORS NOT TO BE GREATER THAN 190mm IN ACCORDANCE WITH BCA 3.9.1.5 THRESHOLDS.

NOTE:

WHERE CONSTRUCTION JOINTS ARE ADJACENT TO A DOOR OR OPENING, THE ARTICULATION JOINTS ARE TO EXTEND ALONGSIDE THE OPENING.

STEP DOWN NOT EXCEED 230mm FOR (L'DRY DOOR, REAR SLIDING DOOR & FRONT DOOR)

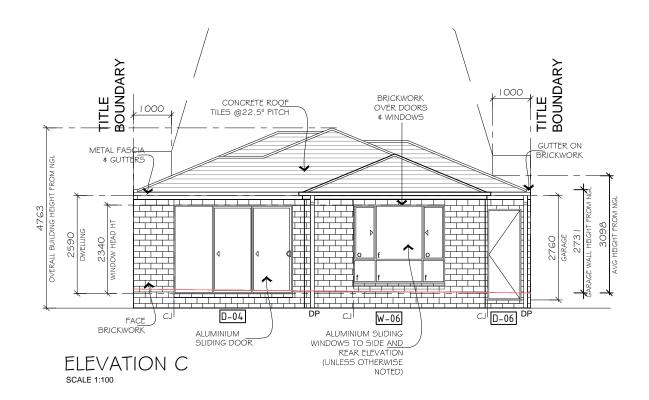

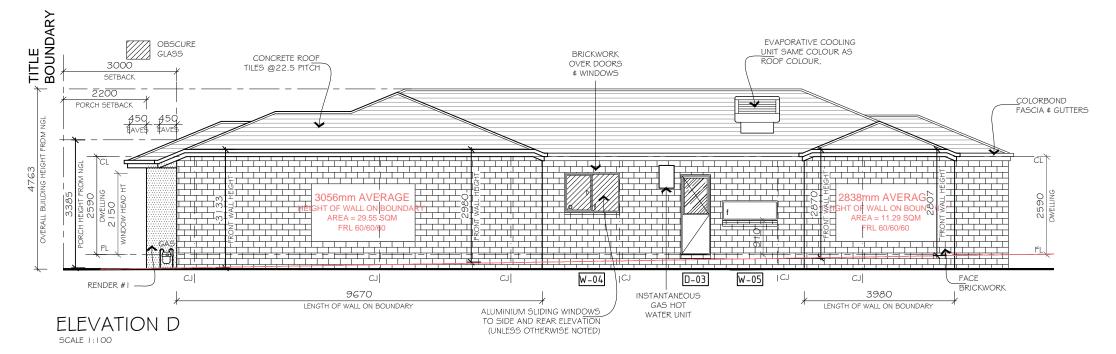

ELEVATIONS

WRITTEN DIMENSIONS TAKE PRECEDENCE OVER SCALE. FLOOR PLAN DIMENSIONS ARE TO FRAME SIZE ONLY.

WINDOW SIZES SHOWN ARE SUPPLIERS FRAME SIZES. ALL GLAZING TO COMPLY WITH A.S. 1288 & AS 2047 GLASS IN BUILDINGS, & WITH A.S. 4055-1992 FOR WINDLOADING.


WINDOW SUPPLIER TO PROVIDE COVER BOARDS TO ALL CORNER WINDOWS U.N.O.

GARAGE ROOF TO BE TIED DOWN MIN. 1200 INTO BRICKWORK WITH HOOP IRON STRAPS.

ALL WATER CLOSET DOORS TO BE REMOVABLE IN ACCORDANCE WITH B.C.A.3.8.3



\vdash	SHEET CONTENT:	sc	6CALE: 1:100		SHEET NUMBER: 5 OF 8	JOB NUMBER:	0001
U	ELEVATIONS: C & D	DA	TE:	29.03.23	B DRAWN: BOH		
ш	PROPERTY ADDRESS: HOUSE - 6	L	ISSUE:	DATE:	DETAILS:		INITIALS:
\neg	LOT 20110 LASIO WAY,		Α	29.03.23	WORKING DRAWING		ВОН
1	DONNYBROOK, VIC, 3064.	ا ـ ا	В	06.04.23	WORKING DRAWING REV-I		ВОН
0	CLIENT:	의	С	16.06.23	WORKING DRAWING REV-2		вон
↵	xxx	510					
اہ							
ш.	WORKING DRAWING	RE					

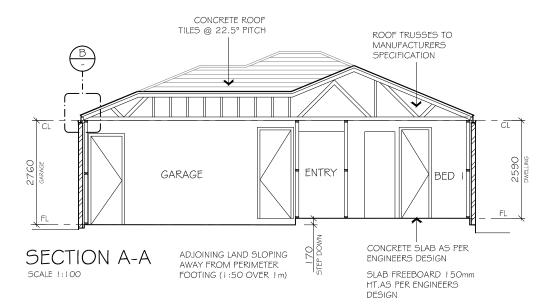

Below are the notes/requirements for 6 Stars:

*Single glazed aluminium window and door frames throughout, with low-e coating to <u>Meals</u> area stacker door only (Southern Star brand or equivalent). See <u>NatHERS</u> report for individual window values and codes

*R6.0 insulation to the ceiling

*R2.7 insulation batts (with reflective foil wrap - Emissivity = 0.56 or less) to external walls, including walls b/n house and Garage (without RFL). No insulation to external Garage walls


*R2.7 insulation batts to internal walls surrounding Bathroom and Laundry only

*Polystyrene waffle pod slab construction

*Self closing exhaust fans throughout, including heater/light/fan combination units (if present)

*Draught seals to all external hinged doors

*Where downlights are used, "Approved Non-Ventilated Covers" are to be installed to avoid insulation removal and minimise air infiltration.

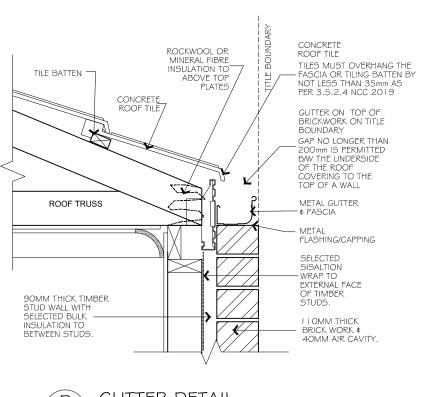



ACCORDANCE WITH FIGURE 3.7.2.3 OF NCC 2019 VOL 2

GARAGE EAVES WITHIN 450mm OF THE TITLE BOUNDARY MUST HAVE A I 6mm FYRCHEK TO THE UNDERSIDE OF THE EAVE \$ TO THE SIDE FACEBORD TO ACHIEVE FIRE RATING WITH FRL OF 60/60/60 TILE BATTEN -EXPOSED EAVE WITHIN 450mm OF THE TITLE BOUNDARY REQUIRES CONCRETE ROOF TILE L6mm FYRCHEK FACEBORD WHERE FACING BOUNDARY ROOF TRUSS METAL GUTTER # FASCIA IOMM THICK PLASTERBOARD CEILING & WALL LINING WITH COVE CORNICE I 6mm FYRECHECK EAVE SHEET 450 FIRE RATED EAVE ON BOUNDARY DETAIL

VENTILATION & INSULATION :

- PROVIDE THERMAL INSULATION ACCORDANCE WITH THE
 REQUIREMENTSOF BUILDING CODE OF AUSTRALIA" PART F6.2 TABLE F 6.1.
 NOTE THAT REFLECTIVE FOIL LAMINATE MUST COMPLY WITH AS 1904 \$
 HAVE A FLAMMABILITY INDEX OF NOT MORE THAN 5.
- MECHANICAL VENTILATION TO BE INSTALLED IN ACCORDANCE WITH PART 3.8.5 OF THE BCA.
- PROVIDE CLEARANCE FROM UNDERSIDE OF BEARER TO FINISHED GROUND LEVEL OF 150mm FOR FLOOR WITH STRIP FLOORING OR 200mm FOR FLOORS WITH PARTICLE BOARD FLOORING OR 300mm WHERE IN TERMITE PRONE AREA.
- SUB FLOOR VENTS TO PROVIDE A RATE OF GOOMM SQ. CLEAR VENTILATION PER I OOOMM RUN OF EXTERNAL MASONRY WALL.
- THERMAL INSULATION TO BE PROVIDED AS FOLLOWS FOR SLAB CONSTRUCTION, (REFER TO ENERGY RATING REPORT) R.F.L TO HAVE FLAMMABILITY INDEX NOT EXCEEDING 5.

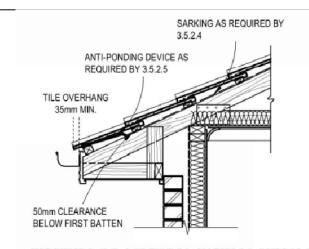


FIGURE 3.5.2.4 TYPICAL INSTALLATION OF ANTI - PONDING DEVICE BOARD

SECTION A-A & DETAILS

NOTES:

WRITTEN DIMENSIONS TAKE PRECEDENCE OVER SCALE. FLOOR PLAN DIMENSIONS ARE TO FRAME SIZE ONLY.

WINDOW SIZES SHOWN ARE SUPPLIERS FRAME SIZES.
ALL GLAZING TO COMPLY WITH A.S. 1288 & AS 2047 GLASS IN BUILDINGS, & WITH A.S. 4055-1992 FOR WINDLOADING.

WINDOW SUPPLIER TO PROVIDE COVER BOARDS TO ALL CORNER WINDOWS U.N.O.


GARAGE ROOF TO BE TIED DOWN MIN. 1200 INTO BRICKWORK WITH HOOP IRON STRAPS.


ALL WATER CLOSET DOORS TO BE REMOVABLE IN ACCORDANCE WITH B.C.A.3.8.3.




SCALE: 1:10 - 450MM EAVES

	\vdash	SHEET CONTENT:	90	ALF.	AS SHOWN	SHEET NUMBER:	JOB NUMBER:	0001
		GECTION + DETAILG	JUALL.		A3 3110W1	6 OF 8		
'	O	SECTION & DETAILS	DA:	TE:	29.03.23	BOH		
	ш	LOT 20110 LASIO WAY, DONNYBROOK, VIC, 3064.	ISSUE:	DATE:	DETAILS:		INITIALS:	
	\neg			Α	29.03.23	WORKING DRAWING		вон
	1			В	06.04.23	WORKING DRAWING REV-I		вон
	0	CLIENT:	8	С	16.06.23	WORKING DRAWING REV-2		вон
	ℴ	xxx	100					
	_		5					
	ᡅ		RE					
		WORKING DRAWING	12∠					

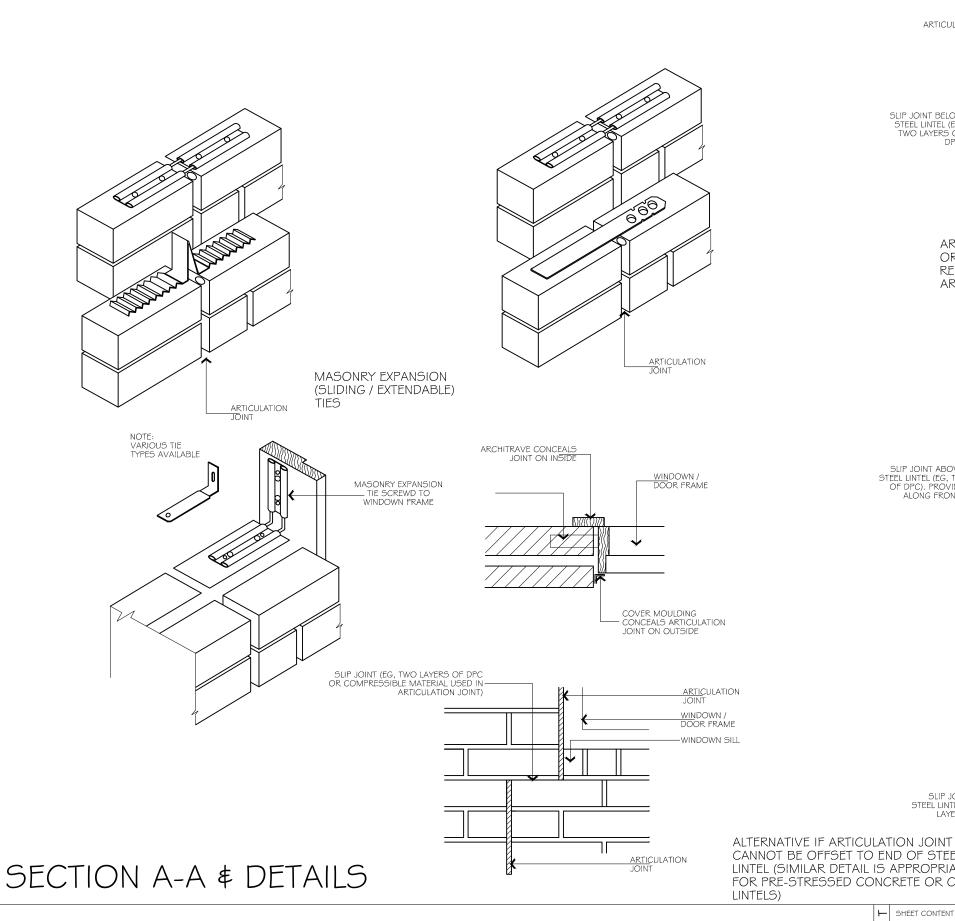


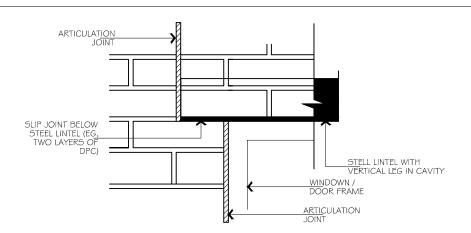

ARTICULATION JOINT OFFSET TO END OF STEEL (OR OTHER) LINTEL OVER OPENING (THIS DETAIL IS RECOMMENDED WHERE POSSIBLE TO ENSURE ARCHING OF MASONRY OVER OPENING)

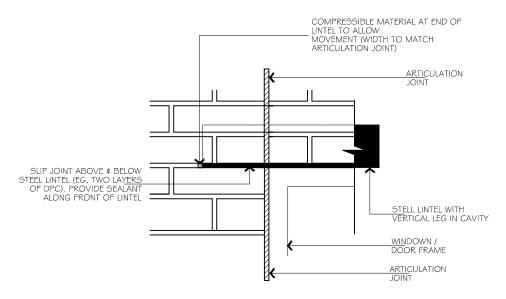

ALTERNATIVE IF ARTICULATION JOINT CANNOT BE OFFSET TO END OF STEEL LINTEL

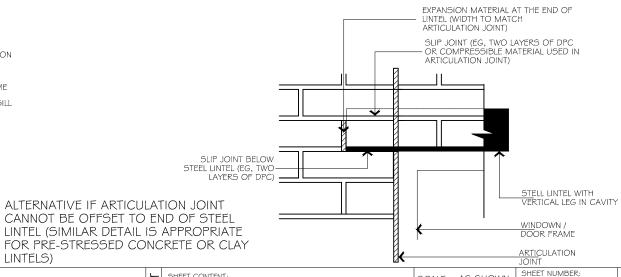

NOTES:

WRITTEN DIMENSIONS TAKE PRECEDENCE OVER SCALE. FLOOR PLAN DIMENSIONS ARE TO FRAME SIZE ONLY.

WINDOW SIZES SHOWN ARE SUPPLIERS FRAME SIZES. ALL GLAZING TO COMPLY WITH A.S. 1288 & AS 2047 GLASS IN BUILDINGS, & WITH A.S. 4055-1992 FOR WINDLOADING.

WINDOW SUPPLIER TO PROVIDE COVER BOARDS TO ALL CORNER WINDOWS U.N.O.

GARAGE ROOF TO BE TIED DOWN MIN. 1200 INTO BRICKWORK WITH HOOP IRON STRAPS.


ALL WATER CLOSET DOORS TO BE REMOVABLE IN ACCORDANCE WITH B.C.A.3.8.3.




your dream home builder

						JOINT		
\vdash	SHEET CONTENT:	SC.	ALE:	AS SHOWN		SHEET NUMBER: 6A OF 8	JOB NUMBER:	0001
S	SECTION # DETAILS	DA.	TE:	29.03.23	3	DRAWN: BOH		
ш	PROPERTY ADDRESS: HOUSE - 6		ISSUE:	DATE:	DE	TAILS:		INITIALS:
_	LOT 20110 LASIO WAY,		Α	29.03.23	WC	DRKING DRAWING		вон
\neg	DONNYBROOK, VIC, 3064.		В	06.04.23	WC	ORKING DRAWING REV-I		вон
0	CLIENT:	SNG	С	16.06.23	WC	DRKING DRAWING REV-2		ВОН
℩	XXX	SIC						
_		$ \Xi $						
₽-	WORKING DRAWING	RE					·	
	· · · · · · · · · · · · · · · · · · ·	-			_			


TYPICAL WALL AND BATH JUNCTIONS MASONRY WALL JUNCTION

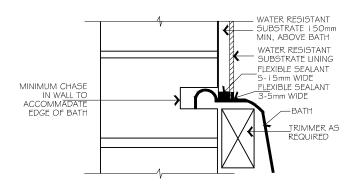


TYPICAL WALL WITH FIXTURES WALL AND BENCHTOP JUNCTION

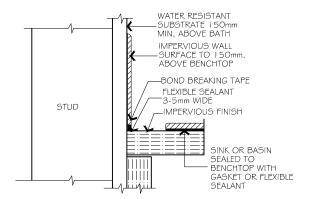


SHOWER TRAY ON TIMBER FLOOR

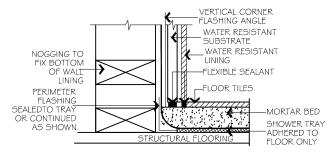


SHOWER TRAY ON CONCRETE FLOOR

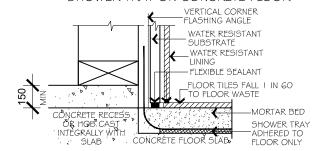


TIMBER WALL JUCTIONS

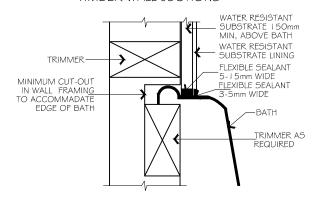


WALL & LAUNDRY SINK JUCTIONS

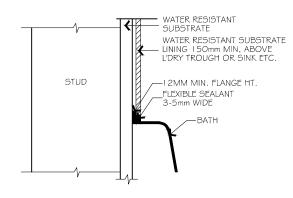


BRICK HOB INSIDE SHOWER TRAY

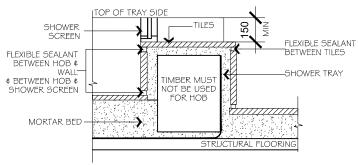

TYPICAL INSTALLATION OF WATER PROOFING MEMBRANE TO SHOWER FLOOR

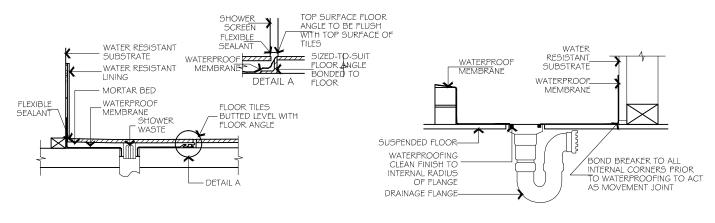

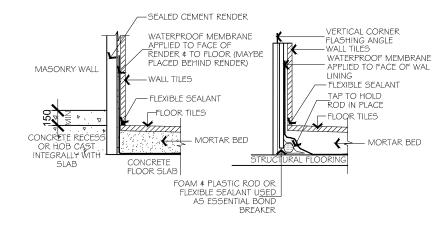

SECTION A-A & DETAILS

NOTES:

WRITTEN DIMENSIONS TAKE PRECEDENCE OVER SCALE. FLOOR PLAN DIMENSIONS ARE TO FRAME SIZE ONLY.

WINDOW SIZES SHOWN ARE SUPPLIERS FRAME SIZES. ALL GLAZING TO COMPLY WITH A.S. 1288 & AS 2047 GLASS IN BUILDINGS, & WITH A.S. 4055-1992 FOR WINDLOADING.

WINDOW SUPPLIER TO PROVIDE COVER BOARDS TO ALL CORNER WINDOWS U.N.O.

GARAGE ROOF TO BE TIED DOWN MIN. 1200 INTO BRICKWORK WITH HOOP IRON STRAPS.

ALL WATER CLOSET DOORS TO BE REMOVABLE IN ACCORDANCE WITH B.C.A.3.8.3.



۲	_	SHEET CONTENT:	SC	ALE:	AS SHOWN	SHEET NUMBER: 6B OF 8	JOB NUMBER:	0001
(ر	SECTION & DETAILS	DA	TE:	29.03.23	DRAWN: BOH		
п	L	PROPERTY ADDRESS: HOUSE - 6		ISSUE:	DATE:	DETAILS:		INITIALS:
-	٦	LOT 20110 LASIO WAY,		Α	29.03.23	WORKING DRAWING		вон
		DONNYBROOK, VIC, 3064.		В	06.04.23	WORKING DRAWING REV-I		вон
	٦ŀ	CLIENT:	SN	С	16.06.23	WORKING DRAWING REV-2		вон
מ	2	XXX	510					
۵			\geq					
-		WORKING DRAWING	RE					

BATH AND WALL FIXTURES-AREA TO BE PROTECTED VERTICAL JUNCTION Waterproofing to internal wet areas and bathrooms is to be in accordance with AS3740. Amend architectural drawings and provide relevant architectural specifications and details to confirm waterproofing systems to be adopted are to be provided, including water stop to shower cubical and VERTICAL JUNCTION the shower floor to have a max1:80 grade to the floor waste FLOOR/BATH JUNCTIONS VESSEL ABUTTING WALL VERTICAL JUNCTION--VERTICAL JUNCTION WALL/BATH JUNCTIONS AROUND A BATH WATER RESISTANT SUBSTRATE MINIMUM CUT-OUT IN WALL FRAMING TO ACCOMMODATE EDGE OF SHOWER BASE - WATER RESISTANT SUBSTRATE -WATER RESISTANT LINING FLEXIBLE SEALANT 5-15mm WIDE FLEXIBLE SEALANT -3-5mm WIDE TAP ASSEMBLY _PRE-FORMED SHOWER BASE TAP ASSEMBLY (MAYNOT BE REQUIRED IF PROPRIETRY FLANGE SEALS THE SURFACE BETWEEN TILE AND WATER RESISTANT SUBSTRATE WATER RESISTANT LINING MORTAR BED TRIMMER ENDCLOSED AND UNENCLOSED SHOWER-AREA TO BE FLEXIBLE SEALANT 5-15mm WIDE PROTECTED 1500 FLEXIBLE SEALANT 3-5mm WIDE MINIMUM CUT-OUT IN WALL PRE-FORMED FRAMING TO ACCOMMODATE-EDGE OF SHOWER BASE VERTICAL CORNER SHOWER BASE SHOWER SCREEN WET AREA SEALANT OR FLANGE AROUND PIPE PENETRATIONS BOTTOM PLATE MORTAR BED VERTICAL AND HORIZONTAL HOB OR WATER STOP ANGLE -JOINT/JUNCTIONS SEALED WITH WATER RESISTANT SEALER SIDE VIEW WATER RESISTANT LINING -WATER RESISTANT SUBSTRATE PLAN VIEW WATER RESISTANT SUBSTRATE -SHOWER WALL WATER RESISTANT LINING STEEL OR TIMBER PACKER FLEXIBLE SEALANT 5-15mm WIDE FLEXIBLE SEALANT FLEXIBLE SEALANT AT THE JUNCTIONS SHOWER TRAY OR WATERPROOF WATERPROOFING TO SHOWER BASE SCREEN FLOOR AREA TO BE WATERPROOF 1.5m MORTAR BED (1:60 FALL TO WASTE)

-MASONY HOB

FLOOR SUBSTRATE

SECTION A-A & DETAILS

-WATER PROOFING REQUIRED

WRITTEN DIMENSIONS TAKE PRECEDENCE OVER SCALE. FLOOR PLAN DIMENSIONS ARE TO FRAME SIZE ONLY.

SHOWER WITH STEP DOWN

WINDOW SIZES SHOWN ARE SUPPLIERS FRAME SIZES. ALL GLAZING TO COMPLY WITH A.S. 1288 & AS 2047 GLASS IN BUILDINGS, & WITH A.S. 4055-1992 FOR WINDLOADING.

WINDOW SUPPLIER TO PROVIDE COVER BOARDS TO ALL CORNER WINDOWS U.N.O.

GARAGE ROOF TO BE TIED DOWN MIN. 1200 INTO BRICKWORK WITH HOOP IRON STRAPS.

ALL WATER CLOSET DOORS TO BE REMOVABLE IN ACCORDANCE WITH B.C.A.3.8.3.



FROM SHOWER ROSE IS NOT ENCLOSED

SHOWER WITH HOB

-	SHEET CONTENT:	SC	ALE:	AS SHOWN	SHEET NUMBER:	JOB NUMBER:	0001
C	SECTION & DETAILS	DA	TE:	29.03.23			
ш	PROPERTY ADDRESS: HOUSE - 6 LOT 20110 LASIO WAY,		ISSUE:	DATE:	DETAILS:		INITIALS:
-	DONNYBROOK, VIC, 3064.		A B	29.03.23	WORKING DRAWING WORKING DRAWING REV-1		BOH BOH
C	CLIENT:	SN	С	16.06.23	WORKING DRAWING REV-2		вон
ω	xxx	20					
_ ا		15					
	WORKING DRAWING	R					

MORTAR BED

LEGEND STANDARD BATTEN LED DOWNLIGHT (AS SELECTED)

CEILING EXHAUST FAN SINGLE GPO - 300mm

SINGLE GPO - I I OOmm SINGLE GPO - 1350mm

DOUBLE GPO - EXTERNAL WEATHERPROOF

EXTERNAL LIGHT POINT

WALL LIGHT BATTEN HOLDER - EXTERNAL

SINGLE GPO - FOR M/WAVE @ 750mm(h)

SINGLE GPO - D/WASHER @ 750mm(h) \Re DOUBLE GPO - 300mm DOUBLE GPO - 1100mm

> DOUBLE GPO - 1350mm TELEVISION POINT SMOKE DETECTOR

FLOOD LIGHT - SINGLE D DATA POINT

JUNCTION BOX

TERMINATION POINT T TELEPHONE POINT AB ACP ALARM SYSTEM (WITH 3 SENSORS)

DOOR CENTRE

THERMOSTAT

CEILING HEATING DUCT (APPROX LOCATION)

POWER POINT FOR GARAGE REMOTE PANEL DOOR - LOCATE ON CEILING 3300mm FROM DOOR OPENING LINTEL \$ 200mm OFF

EVAPORATIVE COOLING DUCT

 \triangleleft ALARM SENSOR

E

NOTE:

INT AUDIO VIDEO INTERCOM

EXHAUST FAN FLOW RATES AS PER

BATHROOM OR SANITARY COMPARTMENT -251/s

CLAUSE 3 8 7 3 OF NCC 2019

KITCHEN OR L'DRY - 40L/s

DUCTED HEATING UNIT LOCATION

МН ROOF ACCESS

DB DOOR BELL 1200 FLUORO - SINGLE

HEATER/FAN UNIT - 2 GLOBE

(00) HEATER/FAN LINIT - 4 GLOBE

RA

PROVIDE EXHAUST FANS,

RANGEHOOD ETC, ARE TO VENT

TO THE OUTSIDE ATMOSPHERE

HROUGH ROOF VIA WHIRLY BIRD

RETURN AIR

SMOKE ALARMS TO ALL BED ROOMS & CORRIDOR IN ACCORDANCE WITH PART

NCC PART 3.12.5.5 ARTIFICIAL LIGHTING LAMP POWER DENSITY SHALL NOT EXCEED: 5W/sq.m FOR CLASS 1 BUILDING

4W/sq.m FOR VERANDAH, ALFRESCO, PORCH OR BALCONY 3W/sq.m FOR CLASS 10a BUILDING PERIMETER LIGHTING TO BE CONTROLLED BY A SENSOR OR HAVE A MAXIMUM OF 40 LUMENS PER WATT. SMOKE DETECTORS TO BE INTERCONNECTED AS PER NCC 2015

THE DWELLING

ARTIFICIAL LIGHTING WATTAGE ALLOWABLE CURRENT CURRENT TOTAL ARFA ALLOWABLE ROOM WATTAGE TOTAL (m²)PER (m²) WATTAGE WATTAGE PORCH/ALFRESCO 6.36 25.44 1.73 W/m² GARAGE 36.05 3 W/m² 108.15 W 0.31 W/m² 5 W/m² 751.10 W 353 2.35 W/m² GROUND 150.22 1.95 W/m² TOTAL 192.63 375

> SMOKE DETECTORS SMOKE DETECTORS TO BE INSTALLED IN ACCORDANCE WITH AS3786-2014. LOCATE A MIN 300mm FROM WALLS \$ DOORWAYS \$ BE HARDWIRED \$ INTERCONNECTED THROUGHOUT

> > SMOKE DETECTORS: SMOKE ALARMS ARE TO BE PROVIDED WITH A BATTERY BACK-UP AND TO BE HARDWIRED IN ACCORDANCE WITH NCC 2019

ALL LIGHT SWITCHES ARE LOCATED 1 050MM FROM FLOOR LEVEL UNLESS NOTTED OTHERWISE.

NOTE:

PROVIDE EXHAUST FANS, RANGEHOOD ETC, ARE TO VENT TO THE OUTSIDE ATMOSPHERE.

HEATING & COOLING OUTLET LOCATIONS ARE IN APPROXIMATE POSITIONS ONLY & ARE SUBJECT TO VERIFICATION BY HEATING CONTRACTOR.

ALL MECHANICAL VENTILATION MUST BE DISCHARGED TO THE OUTSIDE

NOTE:

THIS IS OPTICOMM ESTATE: ONT CONNECTION REQUIRED - BY OTHERS.

PROVIDE SINGLE GPO AND BATTEN LIGHT TO ROOF SPACE - CLOSE TO MANHOLE

7 11 11 11 11 11 11 11 11 11 11 11 * 88 SENSOR BY CLIENT Q 0 --Ε COOLING ONT 2 TINU MB SD WE STP Ε Ε Ε D 0 _ \$

ELECTRICAL

WRITTEN DIMENSIONS TAKE PRECEDENCE OVER SCALE, FLOOR PLAN DIMENSIONS ARE TO FRAME SIZE ONLY.

WINDOW SIZES SHOWN ARE SUPPLIERS FRAME SIZES. ALL GLAZING TO COMPLY WITH A.S. 1288 & AS 2047 GLASS IN BUILDINGS, & WITH A.S. 4055-1992 FOR WINDLOADING.

WINDOW SUPPLIER TO PROVIDE COVER BOARDS TO ALL CORNER WINDOWS U.N.O. GARAGE ROOF TO BE TIED DOWN MIN. 1200 INTO BRICKWORK WITH

HOOP IRON STRAPS. ALL WATER CLOSET DOORS TO BE REMOVABLE IN ACCORDANCE

WITH B.C.A.3.8.3




F	-	SHEET CONTENT:	SCALE: 1:100			SHEET NUMBER: 7 OF 8	JOB NUMBER:	0001
ر	כ	ELECTRICAL	DA	TE:	29.03.23	B DRAWN: BOH		
ш		PROPERTY ADDRESS: HOUSE - 6 LOT 20110 LASIO WAY,		ISSUE:		DETAILS: WORKING DRAWING		INITIALS: BOH
		DONNYBROOK, VIC, 3064.	₀	В		WORKING DRAWING REV-1 WORKING DRAWING REV-2		BOH BOH
۵		CLIENT: XXX	NO.	C	18.08.23	WORKING DIAWING KEV-2		DOIT
۵			<u>S</u>					
		WORKING DRAWING	RE					

ROOFING: COMPANY BRISTILE, PROFILE: SHINGLE, COLOR: CHARCOAL.



CONCRETE ROOF TILE

BUILDERS WHITE

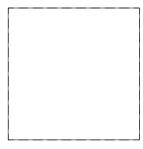

EAVES LINING

BRICKS: TAWNY HERITAGE (COMPANY SELKIRK)



• FACE BRICKS

MERBAU STAINED FINISH



• FRONT DOOR

MONUMENT



DOWNPIPES

FASCIA

GUTTER WINDOWS

RENDER 1

COMPANY: GLIDEROLE, COLOR: CAOBA, PROFILE: MADISON.



GARAGE DOOR

MONUMENT



LETTER BOX

EXPOSED AGGREGATE (BLACK AND WHITE COLOR)



EXPOSED AGGREGATE DRIVE WAY

SCHEDULE OF MATERIALS & FINISHES

 $\overline{\text{WRITTEN DIMENSIONS TAKE PRECEDENCE OVER SCALE. FLOOR}$ PLAN DIMENSIONS ARE TO FRAME SIZE ONLY.

WINDOW SIZES SHOWN ARE SUPPLIERS FRAME SIZES. ALL GLAZING TO COMPLY WITH A.S. 1288 & AS 2047 GLASS IN BUILDINGS, & WITH A.S. 4055-1992 FOR WINDLOADING. WINDOW SUPPLIER TO PROVIDE COVER BOARDS TO ALL CORNER

WINDOWS U.N.O. GARAGE ROOF TO BE TIED DOWN MIN. 1200 INTO BRICKWORK WITH HOOP IRON STRAPS.

ALL WATER CLOSET DOORS TO BE REMOVABLE IN ACCORDANCE WITH B.C.A.3.8.3.



	-	SHEET CONTENT:	sc	ALE:	1:100	SHEET NUMBER: 8 OF 8	JOB NUMBER:	0001
1	ပ	SCHEDULE OF MATERIALS	DA	TE:	29.03.23	B DRAWN: BOH		
1	ш	PROPERTY ADDRESS: HOUSE - 6		ISSUE:	DATE:	DETAILS:		INITIALS:
	\neg	LOT 20110 LASIO WAY, DONNYBROOK, VIC, 3064.	- S	Α	29.03.23	WORKING DRAWING		вон
				В	06.04.23	WORKING DRAWING REV-I		BOH
- 1		CLIENT:		С	16.06.23	WORKING DRAWING REV-2		ВОН
1	\sim	XXX	100					
	_		18					
	ጉ-	WORKING DRAWING	RE					