# General Notes (NCC 2022 Vol 2)

- I. All materials and work practices shall comply with, but not limited to the Building Regulations 2018, National Construction Code Series 2022 Building Code of Australia Vol 2 and all relevant current Australian Standards (as amended) referred to therein.
- 2. Unless otherwise specified, the term BCA shall refer to National Construction Code Series 2022 Building Code of Australia Volume
- 3.All materials and construction practice shall meet the Performance Requirements of the BCA. Where a performance solution is proposed then, prior to implementation or installation, it first must be assessed and approved by the Relevant Building Surveyor as meeting the Performance Requirements of the BCA.
- 4. All Glazing shall be in accordance with part 8.3 of NCC 2022 VOL 2 \$ AS | 288-202 | WHERE IN
- Windows glazingwithin 500mmof the floor level shall be 5mm thickned annealed
- Glazed doors and associate side panels shall be 4mm toughened safety glass
- Kitchen, Bathroom and Ensuite glazing within 2.0m of the finished floor or bottom of bath/shower base shall be 3mm toughened safety glass
- Shower screens shall be grade a safety glass
- 5. Waterproofing of wet areas, being bathrooms, showers, shower rooms, laundries, sanitary compartments and the like shall be provided in accordance with part 10.2 of the NCC 2022 VOL 2 \$ AS 3740-2021: 15. These drawings shall be read in conjunction with all relevant Waterproofing of Domestic Wet Areas.
- These Drawings shall be read in conjunction with any House Energy Rating (HERS) report and shall be constructed in 16.5ite plan measurements in metres - all other measurements in accordance with the stamped plans endorsed by the accredited Thermal Performance Assessor without alteration.
- Step sizes (other than for spiral stairs) to be:
- > Risers (R) 190mm maximum and 115mm minimum
- > Going (G) 355mm maximum and 240mm minimum
- $\rightarrow$  2R + 1G = 700mm maximum and 550mm minimum
- > with less than 125mm gap between open treads.
- 8.All treads, landings and the like to have a slip-resistance classification of P3 or R10 for dry surface conditions and P4 or R11 for wet surface conditions, or a nosing strip with a slip-resistance classification of P3 for dry surface conditions and P4 for wet surface conditions
- 9. Provide barriers where change in level exceeds 1000mm above the surface beneath landings, ramps and/or treads. Barriers (other than tensioned wire barriers) to be:
  - > 1000mm min. above finished surface level of balconies, landings or the like, and
  - > 865mm min. above finished surface level of stair nosing or ramp,
  - > vertical with less than 125mm gap between, and
  - > any horizontal element within the barrier between 150mm and 760mm above the floor must not facilitate climbing where changes in level exceeds 4000mm above the surface beneath landings, ramps and/or treads.

Wire barrier construction to comply with Part 11.3 THE ncc 2022 23.

- 10. Top of hand rails to be minimum 865mm vertically above stair nosing and floor surface of ramps
- II. Window sizes nominated are nominal only. Actual size may vary according to manufacturer. Windows to be flashed all around.

Where the building (excludes a detached Class 10) is located in a termite prone area the building is to be provided with a termite management system.

# 12.Concrete stumps:

- > up to 1400mm long to be 100mm x 100mm (1 No. H.D. Wire)
- > 1401mm to 1800mm long to be 100mm x 100mm (2 No. H.D.
- > 1801mm to 3000mm long to be 125mm x 125mm (2 No. H.D.
- > 100mm x 100mm stumps exceeding 1200mm above ground level to be braced where no perimeter base brickwork provided.
- 13. Buildings in marine or other exposure environments shall have masonry units, mortar and all built in components and the like complying with the durability requirements of Table 4.1 of AS 4773.1-2015 'Masonry in small buildings' Part 1: Design.
- 14. All stormwater to be taken to the legal point of discharge to the Relevant Authorities approval.
- structural and all other consultants' drawings/ details and with any other written instructions issued in the course of the contract.
- millimetres unless noted otherwise.
- 17. Figured dimensions take precedence over scaled dimensions.
- 18. The Builder shall take all steps necessary to ensure the stability and general water tightness of all new and/or existing structures during all works.
- 19. The Builder and Subcontractors shall check and verify all dimensions, setbacks, levels and specifications and all other relevant documentation prior to the commencement of any works. Report all 29. discrepancies to this office for clarification.
- Installation of all services shall comply with the respective supply authority requirements.
- The Builder and Subcontractor shall ensure that all stormwater drains, sewer pipes and the like are located at a 30. sufficient distance from any buildings footing and/ or slab edge beams so as to prevent general moisture penetration, dampness, weakening and undermining of any building and its footing system.
- These plans have been prepared for the exclusive use by the Client of [Insert Drafting Service] ('The Designer') for the purpose expressly notified to the Designer. Any other person who uses or relies on these plans without the Designer's written consent does so at their own risk and no responsibility is accepted by the Designer for such use and/or reliance.

- A building Permit is required prior to the commencement of 32. these works. The release of these documents is conditional to the Owner obtaining the required Building Permit.
- The Client and/or the Client's Builder shall not modify or amend the plans without the knowledge and consent of [building designer's name] except where a Registered Building Surveyor makes minor necessary changes to facilitate the Building Permit application and that such changes are promptly reported back to [building designer's name].
- The approval by this office of a substitute material, work practice, variation or the like is not an authorisation for its use or a contract variation. All variations must be accepted by all parties to the agreement and where applicable the Relevant Building Surveyor prior to implementing any variation.
- STORMWATER 100 mm DIA. Class 6 UPVC stormwater line laid to a minimum grade of 1:100 and connected to the legal point of stormwater discharge. Provide inspection openings at 9000mm C/C and at each change of direction.
  - > The cover to underground stormwater drains shall be not less
  - > 100mm under soil
  - ! 50mm under paved or concrete areas
  - ! I 00mm under unreinforced concrete or paved driveways
- ! 75mm under reinforced concrete driveways
- SITE ENVIRONMENT DESIGN INFORMATION (if applicable)
- > Site Bushfire Attack Assessment (simplified method) 1.Reference document 'AS 3959-2018 construction of
  - buildings in bush fire prone areas'
  - Relevant Fire Danger Index (FDI)-
  - Predominate vegetation:- Classification
  - IV. Type
  - Distance of site from predominate vegetation-
  - Effective slope of land-
  - vii. Determination of Bushfire attack Level (BAL)-
- Site Classification (if Applicable)
- > Site classification as Class:
- > Refer to soil report No:
- Design Gust Wind Speed / Wind Classification
- > Building tie-downs to be provided in accordance with AS I 684-2021 for an assumed design gust wind speed / wind classification of NI/N2 (subject to confirmation on site by Relevant Building Surveyor at first inspection) refer to ASI684 for construction requirements.
- Climate Zone Climate zone for thermal design / thermal performance assessment: Zone 6 \$ 7
- Corrosion protection of built-in structural members
- > Provide corrosion protection of built-in structural steel members such as steel lintels, shelf angles, connectors, accessories (other than wall ties) in accordance with Table 4.1 of AS4773.1-2015 Masonry in Small Buildings, Part 1: Design suitable for an Environment Classification of [Insert environment • AS 4100-2020 STELL STRUCTURES classification

Corrosion protection for sheet roofing

Provide for sheet roofing in accordance with AS 1562.1-2018 \$ Metal roof battens with part 7.2 of the NCC 2022 VOL 2

# SEE 6 STAR REQUIREMENTS/NOTES OR ENERGY EFFICIENCY

- 35. Thermal insulation must comply with as/nzs 4859-2018 and be intalled as per part 13.2 the NCC 2022 VOL 2
- Thermal onsulation requirements to be determined the energy rating
- 36. Where a pliable building membrane is installed on the exterior side of the insulation layer of an external wall it must be in accordance with part 10.8 of NCC 2022 VOL2
- 38. Tiles to overhang the fascia/tiling batten by not less than 35mm

All works shall comply with not to be limited to the following Australian standards

- AS | 288-202 | GLASS | IN BUILDINGS-SELECTION AND INSTALLATION
- AS 15621-2018 DESIGN AND INSTALLATION OF SHEET ROOF AND WALL CLADDING- METAL
- AS 1684-2021 NATIONAL TIMBER FRAMING CODE
- AS 1860-2006 RESIDENTIAL TIMBER FRAMING CODE
- 2047-2014 WINDOWS IN BUILDINGS-SELECTION AND INSTALLATION
- AS 2049 2002 ROOF TILES
- AS 2050-2018 INSTALLATION OF ROOFING TILES
- 2870-2011 RESIDENTIAL SLABS AND FOOTINGS CONSTRUCTION
- AS 2904- 1995 DAMP PROOF COURSES AND FLASHINGS
- AS 3600-2018 CONCRETE STRUCTURES
- AS 3660.1-2014 PROTECTION OF BUILDING AGAINST SUBTERRANEAN TERMITES PART I NEW BUILDING
- AS 3700-2018 MASONRY STRUCTURES
- AS 3740-2021 WATER PROOFING OF WET AREAS IN RESIDENTIAL BUILDINGS
- AS 3786-2014 SMOKE ALARMS

# NOTES:

HOOP IRON STRAPS.

WITH PART 10.4.2 OF THE NCC 2022 VOL 2

WRITTEN DIMENSIONS TAKE PRECEDENCE OVER SCALE. FLOOR PLAN DIMENSIONS ARE TO FRAME SIZE ONLY. WINDOW SIZES SHOWN ARE SUPPLIERS FRAME SIZES. ALL GLAZING TO COMPLY WITH A.S. 1288-2021 & AS 2047-2014 GLASS IN BUILDINGS, & WITH A.S. 4055-2012 FOR WINDLOADING. WINDOW SUPPLIER TO PROVIDE COVER BOARDS TO ALL CORNER WINDOWS LLN O GARAGE ROOF TO BE TIED DOWN MIN. 1200 INTO BRICKWORK WITH

ALL WATER CLOSET DOORS TO BE REMOVABLE IN ACCORDANCE

DRAFTSPERSON: SEEMA AFTAB DP-AD 68552

-		SCA	ALE: A	S SHOWN	SHEET NUMBER: OF 9	JOB NUMBER:	0001
1	GENERAL NOTES	DAT	E:	23.11.23	B DRAWN: XX		
ш			ISSUE:	DATE:	DETAILS:		INITIALS:
	LOT 253 SIMMENTAL ROAD,		D	29.11.23	WORKING DRAWING REV 3		XX
	MASON QUARTER, WOLLERT, VIC. 3750		E	15.12.23	WORKING DRAWING REV 4		XX
		ਨ	F	20.12.23	WORKING DRAWING REV 5		XX
`	CLIENT:	SION	G	12.01.24	WORKING DRAWING REV 6		XX
Ω	XXXX	l $\widetilde{\omega}$	Н	25.01.24	WORKING DRAWING REV 8		XX
		$\leq$	I	29.01.24	WORKING DRAWING REV 9		XX
σ.		RE	K	02.02.24	WORKING DRAWING REV 10		XX
	WORKING DRAWING	_	L	05.02.24	WORKING DRAWING REV 11		XX

# NOTE:

ROOF DESIGN SHOWN FOR GUIDE PURPODES ONLY, SEE THE ROOF MANUFACTURES DRAWINGS FOR EXACT DESIGN

SIDE REAR & WING FENCE TO BE ONSTRUCTED AS PER DEVELOPERS JIDELINES REQUIREMENTS \$ OMPLETED BY BUILDER

PRIVEWAY & FRONT PATH TO BE

CONSTRUCTED OF EXPOSED

GGREGATE. DRIVEWAY TO BE

COMPLETED BY BUILDER & TO

COMPLY WITH RELEVANT DESIGN

SIDE GATE MUST COMPLEMENT THE

ARCHITECTURAL CHARACTER OF THE DWELLING & MUST NOT BE HIGHER

THAN 1.8M ABOVE THE NATURAL

### NOTE:

DRAINAGE GUIDE SHOWN IS FOR ROOF DRAINAGE ONLY, AI SITE DRAINAGE AS PER PLUMBER & BUILDERS DESIGN BUILDING SURVEYOR TO CONFIRM.

# NOTE:

SITE SCRAPE BUILDING AREA REMOVE EXCESS VEGETATION 4 PROVIDE LEVEL BUILDING LATFORM BUILDER TO VERIFY

# LANDSCAPING:

ANDSCAPING TO COMPLY WITH COMPLETED BY CLIENT AFTER IANDOVER.

# NOTE:

GROUND LEVEL

NOTE:

DRIVE WAY TO BE GRADED TO ENSUR DEVELOPER GUIDELINES & TO BE MAXIMUM 1:6 GRADIENT FROM CROSSOVER TO GARAGE FLOOR

# NOTE:

CONCRETER/BUILDER TO MAKE SURE THAT A MIN 385MM TO BE EXCAVATED BELOW FLOOR LEVEL IN RESIDENCE & GARAGE FOR A WAFFLE SLAB. CHECK ON SITE BEFORE COMMENCING.

# LEVELS:

ALL LEVEL & FINISHED FLOOR LEVELS AREA TAKEN FROM NGINEERING PLAN PROVIDED BY THE COUNCIL STOMWATER NFORMATION CERTIFICATE. BUILDER IS TO VERIFY ON SITE ALL LEVELS PRIOR TO THE COMMENCEMENT OF ANY BUILDING WORKS. NEW LEVELS SHOULD BE DONE TO DETERMINE NEW SITE CONDITIONS

# STROMWATER POINT:

STORMWATER POINT TO BE VERIFIED ON SITE PRIOR TO THE COMMENCMENT OF ANY BUILDING WORKS. STORMWATER LAYOUT AS PER PLUMBERS \$ BUILDERS DESIGN & TO BE CONFIRMED ON SITE BY THE PLUMBER & BUILDER

# NOTE:

ALL SURROUNDING SURFACES ARE TO BE GRADED AWAY FROM THE BUILDING TOWARDS A SUITABLE DRAINAGE FACILITY. TO AVOID ANY LOCAL DAMMING OR PONDING BUILDING SURVEYOR IS TO CHECK AND VERIFY THAT NO SERVICES ARE PLACED WITHIN 45 ANGLE OF REPOSE TO PROPERTY FOOTINGS. NEW FOOTINGS ARE NOT UNDERMINE EXISTING FOOTINGS AND ARE TO MATCH THE DEPTH OF THE EXISTING FOOTINGS, WHERE APPROPRIATE.

# NOTE:

NSTALL SURFACE SPOON DRAINS AND CUT - OFF DRAINS UP SLOPE OF THE BUILDING SITE TO INTERCEPT AND CHANNEL BOTH RUN - OFF AND SHALLOW GROUNDWATER SEEPAGE AWAY FORM THE SITE CUTS AND FOUNDATIONS. CUT OFF DRAINS SHOULD PENETRATE 50mm BELLOW THE UPPER CLAY SURFACE. BUILDER TO BE VERIFY ON SITE PRIOR TO THE COMMENCEMENT OF ANY BUILDING WORKS

ALL CUT AND FILL SHOULD BE BATTERED OR RETAINED PROPERLY AS A GENERAL RULE, BATTERS OF 45 DEGREES TO THE HORIZONTAL FOR CLAYS AND 30 DEGREES TO THE HORIZONTAL FOR SANDS SHOULD B ADOPTED. WHERE THIS IS NOT POSSIBLE OR DESIRED ENGINEER DESIGNED RETAINING WALLS SHOULD BE USED. WHERE SITES ARE PRONE TO LANDSLIPS, A LANDSLIP ASSESSMENT SHOULD BE CARRIED

COMPLETE ACCURACY OF THIS PLAN IS NOT GUARANTEED. DETAILS SHOWN SHOULD BE CHECKED AND PROVED ON SITE BEFORE ANY WORK IS CARRIED OUT.

ALL UTILITY AUTHORITIES SHOULD BE CONTACTED REGARDING THE EXISTENCE OF ANY UNDERGROUND SERVICE ON SITE AND SURROUNDING THE SITE

# **ERMITE NOTE:**

A TERMITE BARRIER TO BE INSTALLED TO MINIMISE T RISK OF TERMITE ATTACK TO PRIMARY BUILDING ELEMENTS IN ACCORDANCE WITH AS3660. I A DURABLE NOTICE MUST BE PERMANENTLY FIXED TO HE BUILDING IN PERMANENT LOCATION, INDICATING

- THE METHOD OF TERMITE RISK MANAGEMENT
- THE DATE OF INSTALLATION OF THE SYSTEM WHERE CHEMICAL BARRIER IS USED ITS LIFE EXPECTANCY AS LISTED ON THE NATIONAL REGISTRATION AUTHORITY LABEL
- THE INSTALLER'S OR MANUFACTURER'S RECOMMENDATIONS FOR THE SCOPE \$ FREQUENCY OF FUTURE INSPECTIONS FOR TERMITE ACTIVITY

# SMALL LOT TYPE A:

CONNECT SWD TO

49,

3500

LEGAL POINT OF DISCHARGE

LOCAL AUTHORITIES POLICY

LOT 251

VACANT AS OF

13/12/2023

L.8M HIGH COLOURBOND

FINISH IN " WOODLAND

AND POST ONLY

GREY" WITH BLACK RAIL

LOT 256

VACANT AS OF 13/12/2023

SITE PLAN

IN ACCORDANCE WITH THE

# NATIONAL BROADBAND NETWORKCO:

THIS IS A FIBRE OPTIC ESTATE BROADBAND LEAD -IN CONDUIT IN ACCORDANCE \ IBN CO.REQUIREMENTS.

6840

RECYCLED WATER TO BE CONNECTED AND INSTALLED IN ACCORDANCE WITH THE RECYCLED WATER PLUMBING GUIDE ISSUED BY THE PLUMBING CONTRACTOR

AS/NZS 3500 Plumbing Regulations RECYCLED WATER MUST BE CONNECTED TO THE DWELLING AS PER DEVELOPERS GUIDELINES:

- RECYCLED WATER RUN IN CONNECTION OF RECYCLED WATER TO ALL APPLICABLE TOILET SUITES
- I X RECYCLED WATER TAP TO REAR OF DWELLING
- I X RECYCLED WATER CONNECTION TO LAUNDRY

PRIVATE OPEN

SPACE 29.75 m2

Фвнз

12150

WALL ON BOUNDARY

LOT 252

VACANT AS OF

13/12/2023

29 52

INSTANTANFOLIS

HOT WATER

**LOT 254** 

VACANT AS OF

13/12/2023

2940

**PROPOSED** 

RESIDENCE FFL: 100.085

3300

8270

WALL ON BOUNDARY

**LOT 253** 

/ACANT AS OF

13/12/2023

# DEVELOPER APPROVAL REQUIRED

# SITING SUBJECT TO **DEVELOPER APPROVAL**

VAPOUR PERMEABLE MEMBRANE MUST BE INSTALLED ON THE EXTERIOR SIDE OF THE PRIMARY INSULATION LAYER OF WALL ASSEMBLIES THAT FORM THE EXTERNAL ENVELOPE OF A BUILDING IN ACCORDANCE WITH PART 10.8 OF NCC 2022 VOL 2

EXPOSED AGGREGATE TO

FRONT PATH (13.6 SQM.)

6470

WALL ON BOUNDARY

GARAGE

7570

WALL ON BOUNDARY

DRIVEWAY, PORCH AND

NOTE

GARAGE EAVES WITHIN 450mm OF HE TITLE BOUNDARY MUST HAVE A Gmm FYRCHEK TO THE UNDERSIDE OF THE EAVE \$ TO THE SIDE FACEBORD TO ACHIEVE FIRE RATING WITH FRL OF 60/60/60

JOB NO

DATE

5000

GARAGE SETOUT

LANTING STRI

22Ø0

700, 2300

3000

SETOUT

SOIL CLASSIFICATION: "H2"

GEOHUB GEOTECHNICAL

250156

: 13/12/2023

### SITE PARTICULARS YES NO FASEMENT 3 0m TO REAR **\**/ ADJOINING PROPERTIES CROSSOVER LOCATIONS R/H SIDE **\**/ BUILDING ENVELOPE ON PROPERTY **BUSHFIRE CONSTRUCTION PROPERTY** \/ TERMITE CONSTRUCTION PROPERTY **ESTATE: MASON QUARTER**

STROURNE ONE CALL. BEFORE YOU

# NOTE

ALL SURFACES AROUND THE HOUSE NEEDS TO BE SLOPED AWAY

# NOTE:

EMPORARY DOWN PIPES URING CONSTRUCTION ONNECTION TO UNDERGROUN TORM WATER SYSTEM.

# NOTE:

STORM WATER DRAINAGE SHALL COMPLY WITH AS3500-2021 \$ 10.7.4 OF NCC 2022 VOL2

# NOTE:

THERE IS NO WALL MOUNTED AIR CONDITIONING UNIT

# NOTE:

ROOF STORMWATER TO BE ACCORANCE WITH AS 3500

90mm DIA DOWNPIPES

# NOTE:

FAVES WITHIN 450mm OF THE ALLOTMENT BOUNDARY MUST ACHIEVE AN FRL OF 60/60/60

# NOTE:

MINIMUM GARDEN AREA OF 25% AS LAND SIZE FALLS B/W 400-500M IN ACCORDANCE WITH REGULATION 76A OF BUILDING 2018.

# TOTAL HOUSE AREA

TOTAL HOUSE AREA 181.14 m<sup>2</sup> SITE AREA 238.0 m<sup>2</sup> SITE COVERAGE 76.11% 30.00 PAVING

PERMEABLE COVERAGE

05.02.24 WORKING DRAWING REV I I

# 11.29 %

# NOTES:

WRITTEN DIMENSIONS TAKE PRECEDENCE OVER SCALE. FLOOR PLAN DIMENSIONS ARE TO FRAME SIZE ONLY. WINDOW SIZES SHOWN ARE SUPPLIERS FRAME SIZES. ALL GLAZING TO COMPLY WITH A.S. 1288-2021 & AS 2047-2014 GLASS IN BUILDINGS, & WITH A.S. 4055-2012 FOR WINDLOADING. WINDOW SUPPLIER TO PROVIDE COVER BOARDS TO ALL CORNER WINDOWS U.N.O. GARAGE ROOF TO BE TIED DOWN MIN. 1200 INTO BRICKWORK WITH

HOOP IRON STRAPS ALL WATER CLOSET DOORS TO BE REMOVABLE IN ACCORDANCE

WITH PART 10.4.2 OF THE NCC 2022 VOL 2

DRAFTSPERSON; SEEMA AFTAB DP-AD 68552

⊢	SHEET CONTENT:	SCA	ALE:	1:200	SHEET NUMBER: 2 OF 9	JOB NUMBER:	0001
S	SITE PLAN	DAT	ΓE:	23.11.23	B DRAWN: XX		
ш	PROPERTY ADDRESS:		ISSUE:	DATE:	DETAILS:		INITIALS:
	LOT 253 SIMMENTAL ROAD,		D	29.11.23	WORKING DRAWING REV 3		XX
	MASON QUARTER, WOLLERT, VIC. 3750	l	E	15.12.23	WORKING DRAWING REV 4		XX
0		S	F	20.12.23	WORKING DRAWING REV 5		XX
	CLIENT:	Ó	G	12.01.24	WORKING DRAWING REV 6		XX
℩	XXXX	l S	Н	25.01.24	WORKING DRAWING REV 8		XX
		۱Ξ	ı	29.01.24	WORKING DRAWING REV 9		XX
٩	WORKING DRAWING	R	K	02.02.24	WORKING DRAWING REV 10		XX
	WORKING DRAWING	12	1	05 02 24	WORKING DRAWING PEV LI		VV

TBM TOP OF ELECTRICITY PIT

ROAD


SIMMENTAL

ETTÉR

ВОХ

С

RL 100.00M

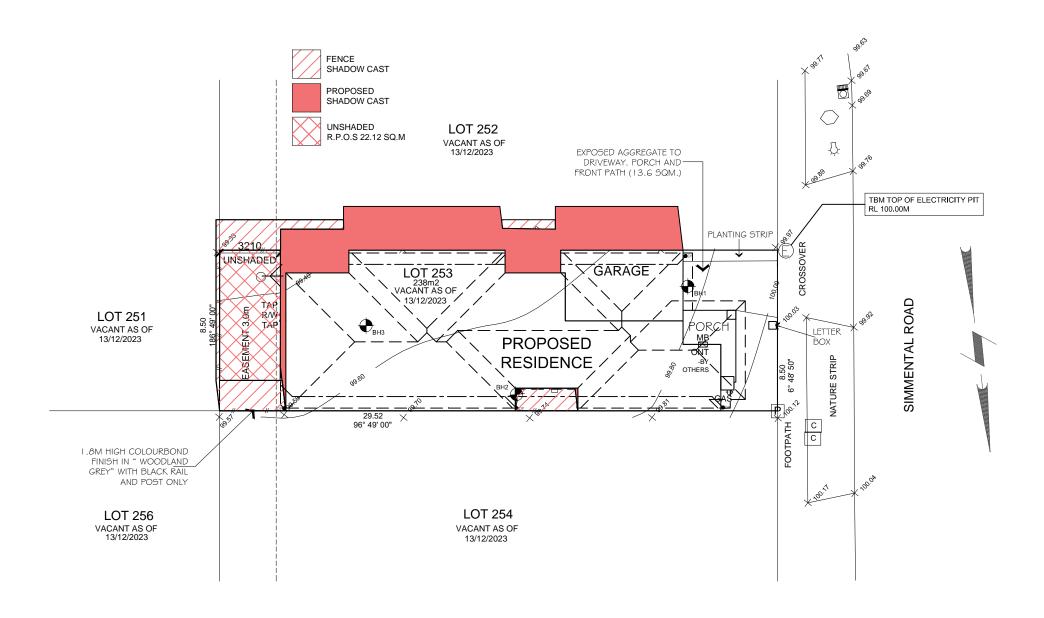

# OVERSHADOWING 12.0PM

# NOTES:

WRITTEN DIMENSIONS TAKE PRECEDENCE OVER SCALE. FLOOR PLAN DIMENSIONS ARE TO FRAME SIZE ONLY.
WINDOW SIZES SHOWN ARE SUPPLIERS FRAME SIZES.
ALL GLAZING TO COMPLY WITH A.S. 1288-2021 & AS 2047-2014 GLASS IN BUILDINGS, & WITH A.S. 4055-2012 FOR WINDLOADING.

IN BUILDINGS, & WITH A.S. 4055-2012 FOR WINDLOADING.
WINDOW SUPPLIER TO PROVIDE COVER BOARDS TO ALL CORNER
WINDOWS U.N.O.

GARAGE ROOF TO BE TIED DOWN MIN. 1200 INTO BRICKWORK WITH HOOP IRON STRAPS.

ALL WATER CLOSET DOORS TO BE REMOVABLE IN ACCORDANCE WITH PART 10.4.2 OF THE NCC 2022 VOL 2  $\,$ 

DRAFTSPERSON; SEEMA AFTAB DP-AD 68552

$\vdash$	SHEET CONTENT:	SCA	1
S	OVERSHADOWING PLAN- I 2PM	DAT	-
ш	PROPERTY ADDRESS: LOT 253 SIMMENTAL ROAD,		
$\neg$	MASON QUARTER, WOLLERT, VIC. 3750		
0	CLIENT:	SNS	ŀ
℩	XXXX	SIC	
۵		EVI	ŀ
	WORKING DRAWING	℩	ŀ

ALE:	1:200	SHEET NUMBER: 2A OF 9	JOB NUMBER:	0001
E:	23.11.2	3 DRAWN: XX		
ISSUE:	DATE:	DETAILS:		INITIALS:
D	29.11.23	WORKING DRAWING REV 3		XX
E	15.12.23	WORKING DRAWING REV 4		XX
F	20.12.23	WORKING DRAWING REV 5		XX
G	12.01.24	WORKING DRAWING REV 6		XX
Н	25.01.24	WORKING DRAWING REV 8		XX
I	29.01.24	WORKING DRAWING REV 9		XX
K	02.02.24	WORKING DRAWING REV 10		XX

L 05.02.24 WORKING DRAWING REV I I

# NOTES: SAFFTY GLAZING ALL GLAZING TO BE IN ACCORDANCE WITH PART 8.3 OF NCC 2022 VOL 2 AS 288-202 | ALL ROOMS WITHIN 500mm VERTICAL OF FLOOR EVEL BATHROOMS ALL GLAZING IN BATHROOMS, ENSUITE, SPA ROOMS OR LIKE, INCLUDING SHOWER DOORS & SCREENS.BATH ENCLOSURES & ASSOCIATED WINDOWS WITHIN 2000mm

VERTICAL FROM THE BATH OR SHOWER BASE OR FINISHED FLOOR LEVEL LAUNDRY WITHIN I 200mm VERTICAL FROM FLOOR EVEL \$/OR WITHIN 300mm VERTICAL OF TROUGH.DOORWAY

WITHIN 300MM HORIZONTAL FROM ALL DOORS

### NOTES

THE WINDOWS NOTED ARE FOR GENERIC SIZE ONLY. THE EXACT SIZE MAY VARY DUE TO WINDOW MANUFACTURERS SPECIFICATIONS, VERIFY ON SITE

### NOTES

AS FROM THE 8TH OF SEPTEMBER 2011 THE GOVERNMENT HAS MADE CHANGES TO ALL PROPERTIES RATING THEM BUSH FIRE PROTECTED SO THE COST OF CONSTRUCTION MAY TO THE CONTRACT PRICE GIVEN AS PER EXTRA CONSTRUCTION REQUIREMENTS TO BE USE TO ACHIEVE A BAL OF 12.5 MINIMUM

BUILDER TO VERIFY ALL BUILDING HEIGHTS AND ALL WRITTEN DIMENSIONS AND SETBACKS BEFORE COMMENCING OF ANY BUILDING WORKS, VERIFY ON SITE

PROVIDE WEEPHOLES @ 960mm MAX. CENTERS WITH CONTINUOUS FLASHING WHERETHE BRICKWORK EXTENDS OVER HE OPENING.

PROVIDE TILED FLOOR FINISH TO ALL WET AREAS.SEE BUILDER RANGE FOR SIZE \$ TYPE.

### PROVIDE EXHAUST FANS, RANGEHOOD ETC, ARE TO VENT TO THE OUTSIDE ATMOSPHERE.

ALL INTERNAL DIMENSIONS ARE TAKEN FROM IMBER STUD TO TIMBER STUD. NOT

NCLUDING PLASTER WALLS.

BEAMS/LINTELS WHICH ARE NOT SPECIFIED ON PLANS SHOULD BE REFERED TO STRUCTURAL ENGINEERS DRAWINGS OR TO BE DESIGNED \$ NOMINATE BY TRUSS MANUFACTURER

# LEGEND

& GAS- GAS METER 

HWS. HOT WATER SYSTEM

# NOTES

- ALL WATER CLOSETS TO HAVE REMOVABLE INGES TO THE DOORS IF THERE IS LESS THAN 1.2m CLEARANCE BETWEEN THE CLOSET PAN \$ THE DOORWAY.
- MAN HOLE LOCATION MAY BE CHANGED DUE TO TRUSS LAYOUT.
- WINDOW AND DOOR FRAME SIZES ARE NOMINAL AND MAY VARY WITH BUILDER'S APPROVED SUPPLIERS.

# SMOKE DETECTORS:

2340 HIGHT INTERNAL DOORS

DECO RANGE 2340 HIGHT INTERNAL DOORS, FLUSH PANEL

INTERNAL HINGED DOORS.

BATHROOMS, ENS & TOILET

NCLUDING ROBES.

PRIVACY LOCKS TO

DOORS.

NOTE:

SMOKE DETECTORS TO BE INSTALLED IN

ACCORDANCE WITH AS 3786-2014. LOCATE A MIN 300mm FROM WALLS & DOORWAYS & BE HARDWIRE INTERCONNECTED THROUGHOUT THE DWELLING

THE DAMP PROOF COURSE MUST TERMINATE AT NO LESS THAN 150mm ABOVE EXTERNAL SURFACES VIA WEEPHOLES, \$ BELOW THE INTERNAL FLOOR LEVEL

PROVIDE A GRADE SAFETY GLASS TO BE INSTALLED IN ALL WET AREA GLAZING ASSEMBLIES WHERE THE LOWEST LINE O SIGHT IS LESS THAN 2 METRERS FROM

THE FINISHED FLOOR LEVEL.

### NOTES: PRIVACY SETS TO BATHROOMS.

SMOKE DETECTORS: SMOKE ALARMS ARE TO BE PROVIDED WITH A BATTERY BACK-UP AND TO BE HARDWIRED IN ACCORDANCE WITH NCC PART 9.5 OF THE NCC 2022 VOL 2

2940

790 "

HOT WATER

1650

L'DRY

### SMOKE DETECTORS SMOKE DETECTORS TO BE HARDWIRED & INTERCONNECTED THROUGHOUT THE DWELLING

6470

6000

3870


WEEPHOLES SHALL BE PROVIDED TO MASONRY WALL @ 1.2m CENTERS \$ ABOVE OPENING GREATER


2330


THAN I.OM


THE ARTIFICIAL LIGHTING PROVISION IS NOT TO EXCEED THE FALLOWING REQUIREMENTS

5 W/m² FOR HABITABLE ROOM SPACES 4 W/m²FOR VERANDAHS OR BALCONIES ATTACHED TO CLASS I BUILDING. 3 W/m2 FOR A CLASS 10 BUILDING SEE ELECTRICAL PLAN AS DETAILED BY A QUALIFIED ELECTRICIAN.

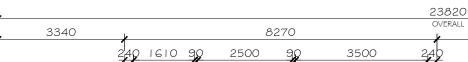

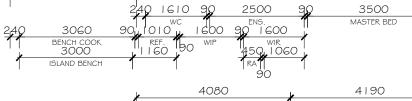

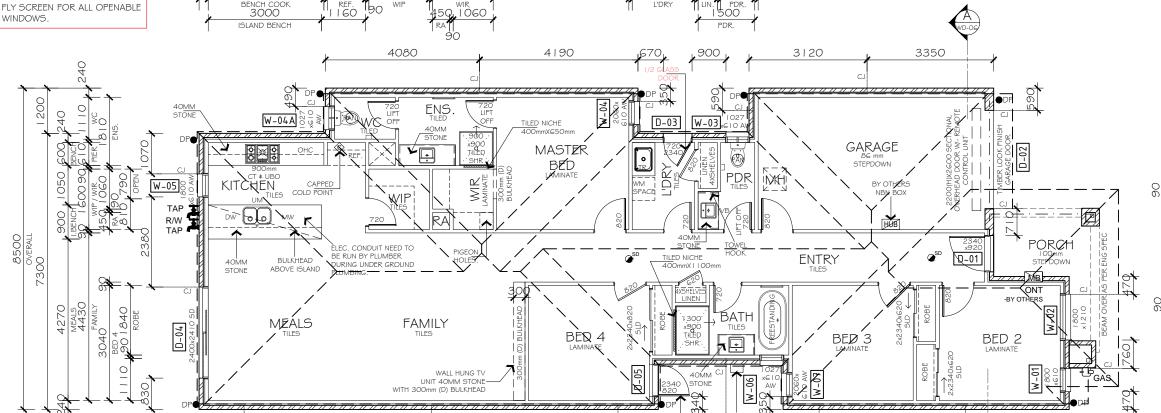

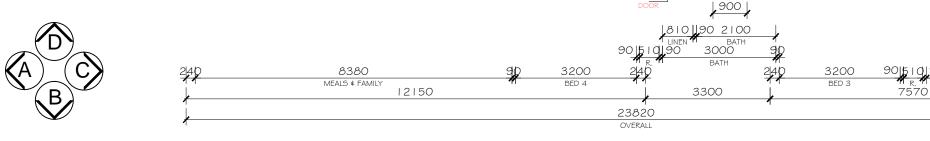

# GROUND FLOOR PLAN

.1190

4950

AREAS		
GROUND FLOOR:	150.62 sq.m	16.21sqrs
GARAGE:	23.59 sq.m	2.54 sqrs
PORCH:	6.93 sq.m	0.75 sqrs
ALFRESCO:	0.0 sq.m	0.00 sqrs
TOTAL:	181.14 sq.m	19.50 sqrs

WRITTEN DIMENSIONS TAKE PRECEDENCE OVER SCALE. FLOOR PLAN DIMENSIONS ARE TO FRAME SIZE ONLY. WINDOW SIZES SHOWN ARE SUPPLIERS FRAME SIZES. ALL GLAZING TO COMPLY WITH A.S. 1288-2021 & AS 2047-2014 GLASS IN BUILDINGS. & WITH A.S. 4055-2012 FOR WINDLOADING. WINDOW SUPPLIER TO PROVIDE COVER BOARDS TO ALL CORNER WINDOWS U.N.O.

GARAGE ROOF TO BE TIED DOWN MIN. 1200 INTO BRICKWORK WITH HOOP IRON STRAPS.

ALL WATER CLOSET DOORS TO BE REMOVABLE IN ACCORDANCE WITH PART 10.4.2 OF THE NCC 2022 VOL 2

DRAFTSPERSON; SEEMA AFTAB DP-AD 68552

4940

GROUND FLOOR PLAN		ALE:	1:100	SHEET NUMBER: 3 OF 9	JOB NUMBER:	0001
		E:	23.11.23	B DRAWN: XX		
PROPERTY ADDRESS:		ISSUE:	DATE:	DETAILS:		INITIALS:
LOT 253 SIMMENTAL ROAD,		D	29.11.23	WORKING DRAWING REV 3		XX
MASON QUARTER, WOLLERT, VIC. 3750		E	15.12.23	WORKING DRAWING REV 4		XX
	$\overline{\mathcal{C}}$	F	20.12.23	WORKING DRAWING REV 5		XX
CLIENT:	lá	G	12.01.24	WORKING DRAWING REV 6		XX
XXXX	S	Н	25.01.24	WORKING DRAWING REV 8		XX
	Ĭ	I	29.01.24	WORKING DRAWING REV 9		XX
WORKING BRANCING	R	K	02.02.24	WORKING DRAWING REV 10		XX
WORKING DRAWING		L	05.02.24	WORKING DRAWING REV		XX

2750

3200

### NOTE:

IT IS BUILDER RESPONSIBILITY TO ESTABLISH THE FINISHED FLOOR LEVELS & FINISHED WALL HEIGHTS IN RELATION TO THE RELEVANT GROUND LEVELS DURING SETOUT & BEFORE ANY EXCAVATION WORKS ARE UNDERTAKEN SO AS TO ENSURE THAT ALL DESIGN ASSUMPTIONS ARE FULLY REALIZE IN PRACTICE & COMPLY WITH THE RELEVANT BUILDING CODES & SITTING REQUIREMENTS.

### NOTE:

USUALLY A SECTIONAL DETAIL IS SHOWN, SHOWING THE DAMP PROOF COURSE TERMINATING BELOW THE INTERNAL FLOOR LEVEL, AND A MIN I OOMM ABOVE EXTERNAL SURFACE. ALSO THIS SECTION WOULD HAVE A NOTE STATING "SURFACE AROUND THE PERIMETER OF DWELLING TO BE GRADED AWAY AT 25MM OVER THE FIRST METRE". THIS SAVE A HEAP OF HEADACHES AT THE END OF THE JOB, WHERE THE WEEP HOLES DON'T HAVE ENOUGH CLEARING, AND THE SURFACE AROUND THE DWELLING HAS NO FALL.

### NOTE:

PROVIDE WEEPHOLES @ 960mm MAX. CENTERS WITH CONTINUOUS FLASHING WHERE THE BRICKWORK EXTENDS OVER THE OPENING.

### NOTE:

WEEP HOLES @ 1.2 METRE SPACING AND ABOVE WINDOWS MORE THAN 1.0 METRE WIDE.

### NOTE:


ROOF DESIGN SHOWN FOR GUIDE PURPOSES ONLY, SEE THE ROOF MANUFACTURES DRAWINGS FOR EXACT DESIGN.

### NOTE:

WHERE CONSTRUCTION JOINTS ARE ADJACENT TO A DOOR OR OPENING, THE ARTICULATION JOINTS ARE TO EXTEND ALONGSIDE THE OPENING

### NOTE

STEP DOWN NOT EXCEED 230mm FOR (L'DRY DOOR, REAR SLIDING DOOR \$ FRONT DOOR)

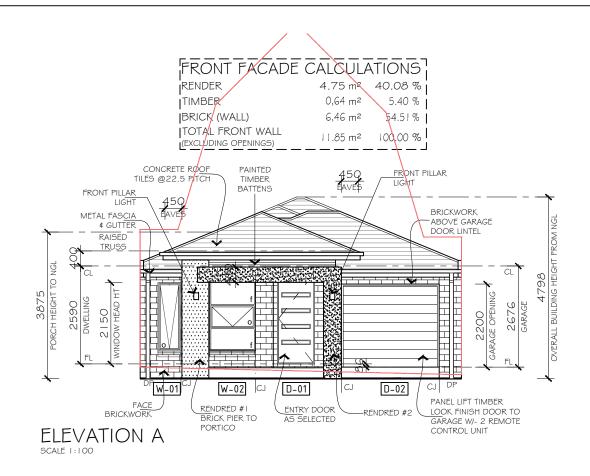

### All lintel sizes to be checked and compared with engineer's specifications/size recommendations WINDOW HEIGHT WIDTH NOTES: NO Aluminium frame awning 1800 610 1 window Aluminium frame awning 2 1800 1210 1 window Aluminium frame awning 3,4A,6 1027 610 window (obscure safety glass) Aluminium frame awning 4,7 2060 610 2 window Aluminium frame awning / 5 1800 610 fix window DOOR NO. WIDTH QTY. **HEIGHT** Designer 920 entry door 2340 920 2 2200 2600 1 Panel lift garage door 1 External 720 door 3 2340 720 4 2400 2410 1 Aluminium sliding door 5 2340 820 1 External 820 door Alternative timber lintels in NOTE:

All Glazing to comply with AS-1288-2006

F27 seasoned hardwood as


per AS 1684.

lo V

W - 04

W - 07

**WINDOW & DOOR SCHEDULE** 

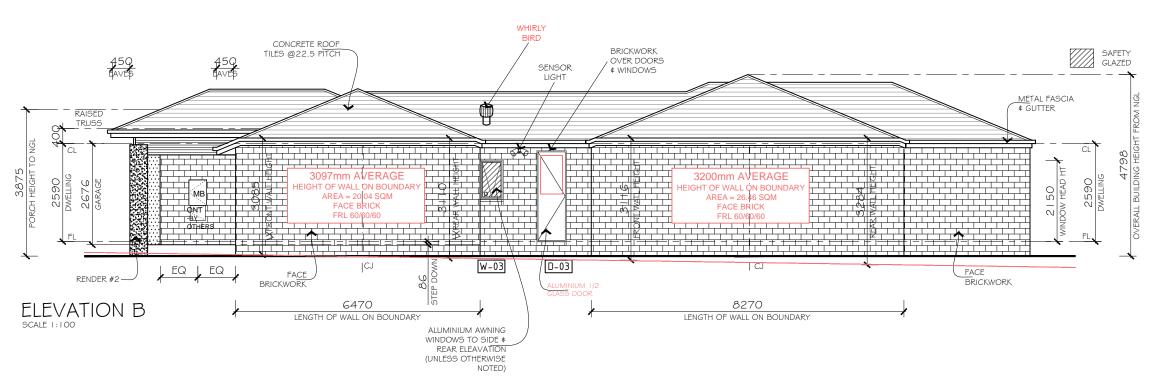

# ELEVATIONS

WRITTEN DIMENSIONS TAKE PRECEDENCE OVER SCALE. FLOOR PLAN DIMENSIONS ARE TO FRAME SIZE ONLY.
WINDOW SIZES SHOWN ARE SUPPLIERS FRAME SIZES.
ALL GLAZING TO COMPLY WITH A.S. 1288-2021 & AS 2047-2014 GLASS IN BUILDINGS, & WITH A.S. 4055-2012 FOR WINDLOADING.
WINDOW SUPPLIER TO PROVIDE COVER BOARDS TO ALL CORNER WINDOWS U.N.O.

GARAGE ROOF TO BE TIED DOWN MIN. 1200 INTO BRICKWORK WITH HOOP IRON STRAPS.

ALL WATER CLOSET DOORS TO BE REMOVABLE IN ACCORDANCE WITH PART 10.4.2 OF THE NCC 2022 VOL 2

DRAFTSPERSON; SEEMA AFTAB DP-AD 68552

0

-	SHEET CONTENT:	SC	ALE:	1:100	SHEET NUMBER: 4 OF 9	JOB NUMBER:	0001
)	ELEVATIONS: A & B	DA <sup>-</sup>	ΓE:	23.11.2	3 DRAWN: XX		
J	PROPERTY ADDRESS:		ISSUE:	DATE:	DETAILS:		INITIALS
.	LOT 253 SIMMENTAL ROAD,		D	29.11.23	WORKING DRAWING REV 3		XX
,	MASON QUARTER, WOLLERT, VIC. 3750		E	15.12.23	WORKING DRAWING REV 4		XX
)	- August	8	F	20.12.23	WORKING DRAWING REV 5		XX
	CLIENT:	Ó	G	12.01.24	WORKING DRAWING REV 6		XX
_	XXXX	Š	Н	25.01.24	WORKING DRAWING REV 8		XX
		Š	- 1	29.01.24	WORKING DRAWING REV 9		XX
-	WORKING DRAWING	R	K	02.02.24	WORKING DRAWING REV 10		XX
	WORKING DRAWING		L	05.02.24	WORKING DRAWING REV 11		XX

### NOTE:

IT IS BUILDER RESPONSIBILITY TO ESTABLISH THE FINISHED FLOOR LEVELS & FINISHED WALL HEIGHTS IN RELATION TO THE RELEVANT GROUND LEVELS DURING SETOUT & BEFORE ANY EXCAVATION WORKS ARE UNDERTAKEN SO AS TO ENSURE THAT ALL DESIGN ASSUMPTIONS ARE FULLY REALIZE IN PRACTICE & COMPLY WITH THE RELEVANT BUILDING CODES \$ SITTING REQUIREMENTS.

USUALLY A SECTIONAL DETAIL IS SHOWN, SHOWING THE DAMP PROOF COURSE TERMINATING BELOW THE INTERNAL FLOOR LEVEL, AND A MIN TOOMM ABOVE EXTERNAL SURFACE. ALSO THIS SECTION WOULD HAVE A NOTE STATING "SURFACE AROUND THE PERIMETER OF DWELLING TO BE GRADED AWAY AT 25MM OVER THE FIRST METRE". THIS SAVE A HEAP OF HEADACHES AT THE END OF THE JOB, WHERE THE WEEP HOLES DON'T HAVE ENOUGH CLEARING, AND THE SURFACE AROUND THE DWELLING HAS NO FALL.

NOTE: PROVIDE WEEPHOLES @ 960mm MAX. CENTERS WITH CONTINUOUS FLASHING WHERE THE BRICKWORK EXTENDS OVER THE OPENING


WEEP HOLES @ 1.2 METRE SPACING AND ABOVE WINDOWS MORE THAN I.O METRE WIDE.


# NOTE:

ROOF DESIGN SHOWN FOR GUIDE PURPOSES ONLY, SEE THE ROOF MANUFACTURES DRAWINGS FOR EXACT DESIGN

WHERE CONSTRUCTION JOINTS ARE ADJACENT TO A DOOR OR OPENING, THE ARTICULATION JOINTS ARE TO EXTEND ALONGSIDE THE OPENING.

STEP DOWN NOT EXCEED 230mm FOR (L'DRY DOOR, REAR SLIDING DOOR & FRONT DOOR)

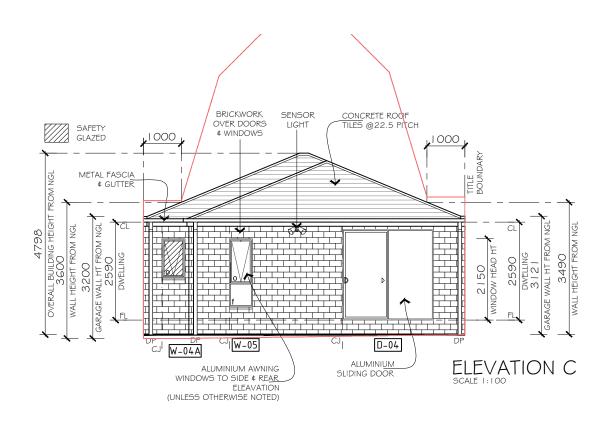

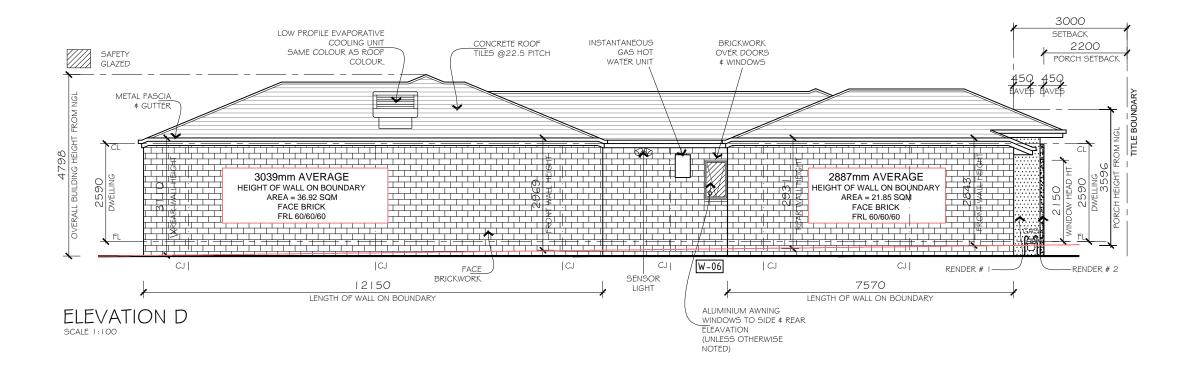

0

# ELEVATIONS

WRITTEN DIMENSIONS TAKE PRECEDENCE OVER SCALE. FLOOR PLAN DIMENSIONS ARE TO FRAME SIZE ONLY. WINDOW SIZES SHOWN ARE SUPPLIERS FRAME SIZES.

ALL GLAZING TO COMPLY WITH A.S. 1288-2021 & AS 2047-2014 GLASS IN BUILDINGS, & WITH A.S. 4055-2012 FOR WINDLOADING. WINDOW SUPPLIER TO PROVIDE COVER BOARDS TO ALL CORNER WINDOWS U.N.O.

GARAGE ROOF TO BE TIED DOWN MIN. 1200 INTO BRICKWORK WITH HOOP IRON STRAPS.

ALL WATER CLOSET DOORS TO BE REMOVABLE IN ACCORDANCE WITH PART 10.4.2 OF THE NCC 2022 VOL 2

DRAFTSPERSON; SEEMA AFTAB DP-AD 68552

SHEET CONTENT:	SCA	ALE:	1:100	SHEET NUMBER: 5 OF 9	JOB NUMBER:	0001
ELEVATIONS: C # D	DAT	E:	23.11.23	3 DRAWN: XX		
PROPERTY ADDRESS:		ISSUE:	DATE:	DETAILS:		INITIALS:
LOT 253 SIMMENTAL ROAD,		D	29.11.23	WORKING DRAWING REV 3		XX
MASON QUARTER, WOLLERT, VIC. 3750		E	15.12.23	WORKING DRAWING REV 4		XX
	ਹ	F	20.12.23	WORKING DRAWING REV 5		XX
CLIENT:	á	G	12.01.24	WORKING DRAWING REV 6		XX
XXXX	ິດ	Н	25.01.24	WORKING DRAWING REV 8		XX
	Ī	- 1	29.01.24	WORKING DRAWING REV 9		XX
WORKING DRAWING	믮	K	02.02.24	WORKING DRAWING REV 10		XX
WORKING DRAWING		L	05.02.24	WORKING DRAWING REV		XX

# CONCRETE ROOF ROOF TRUSSES TO TILES @ 22.5° PITCH MANUFACTURERS SPECIFICATION BED 2 ENTRY GARAGE ADJOINING LAND SLOPING SLAB AS PER ENGINEERS AWAY FROM PERIMETER DESIGN FOOTING (1:50 OVER 1m) SLAB FREEBOARD 150mm HT.AS PER ENGINEERS SECTION A-A

# 6 STAR REQUIREMENTS :

Below are the notes/requirements for 6 Stars:

\*Single glazed aluminium window and door frames throughout (Southern Star brand or equivalent). See NatHERS report for individual window values and codes

\*R3.0 insulation to the ceiling


\*R2.0 insulation batts (with reflective foil wrap - Emissivity = 0.56 or less) to external walls, including walls b/n house and Garage (without RFL). No insulation to external Garage walls

\*Polystyrene waffle pod slab construction


\*Self closing exhaust fans throughout, including heater/light/fan combination units (if present)

\*Draught seals to all external hinged doors

\*Where downlights are used, "Approved Non-Ventilated Covers" are to be installed to avoid insulation removal and minimise air infiltration.

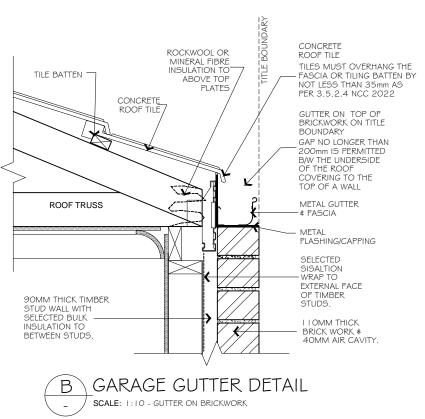



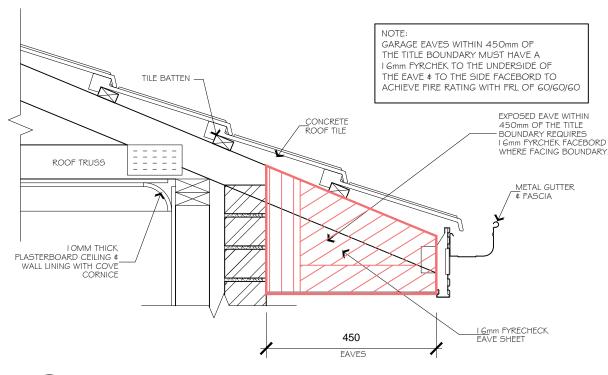

FIRE RATED EAVE ON BOUNDARY DETAIL

SCALE: 1:10 - 450MM EAVES

VENTILATION & INSULATION :

- PROVIDE THERMAL INSULATION ACCORDANCE WITH THE REQUIREMENTSOF"BUILDING CODE OF AUSTRALIA" PART F6.2 TABLE F 6.1 NOTE THAT REFLECTIVE FOIL LAMINATE MUST COMPLY WITH AS 1904 \$ HAVE A FLAMMABILITY INDEX OF NOT MORE THAN 5.
- MECHANICAL VENTILATION TO BE INSTALLED IN ACCORDANCE WITH PART 10.8.2 OF THE NCC 2022 VOL 2.
- PROVIDE CLEARANCE FROM UNDERSIDE OF BEARER TO FINISHED GROUND LEVEL OF 150mm FOR FLOOR WITH STRIP FLOORING OR 200mm FOR FLOORS WITH PARTICLE BOARD FLOORING OR 300mm WHERE IN TERMITE PRONE AREA.
- SUB FLOOR VENTS TO PROVIDE A RATE OF GOOMM SQ. CLEAR VENTILATION PER LOOMM RUN OF EXTERNAL MASONRY WALL.
- THERMAL INSULATION TO BE PROVIDED AS FOLLOWS FOR SLAB CONSTRUCTION. (REFER TO ENERGY RATING REPORT) R.F.L TO HAVE FLAMMABILITY INDEX NOT EXCEEDING 5.

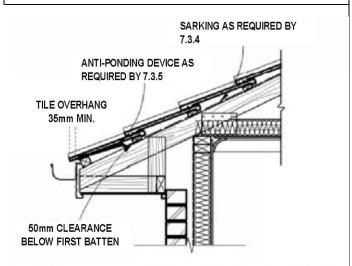


FIGURE 7.3.5 TYPICAL INSTALLATION OF ANTI-PONDING DEVICE BOARD

# SECTION A-A & DETAILS


WRITTEN DIMENSIONS TAKE PRECEDENCE OVER SCALE. FLOOR PLAN DIMENSIONS ARE TO FRAME SIZE ONLY.
WINDOW SIZES SHOWN ARE SUPPLIERS FRAME SIZES.
ALL GLAZING TO COMPLY WITH A.S. 1288-2021 & AS 2047-2014 GLASS IN BUILDINGS, & WITH A.S. 4055-2012 FOR WINDLOADING.
WINDOW SUPPLIER TO PROVIDE COVER BOARDS TO ALL CORNER WINDOWS U.N.O.


GARAGE ROOF TO BE TIED DOWN MIN. 1200 INTO BRICKWORK WITH HOOP IRON STRAPS.

ALL WATER CLOSET DOORS TO BE REMOVABLE IN ACCORDANCE WITH PART 10.4.2 OF THE NCC 2022 VOL 2


DRAFTSPERSON; SEEMA AFTAB DP-AD 68552

⊢	SHEET CONTENT:	SCA	ALE: A	AS SHOWN	SHEET NUMBER:  6 OF 9	JOB NUMBER:	000
S	SECTION A-A & DETAILS	DAT	E:	23.11.2			
ш	PROPERTY ADDRESS:		ISSUE:	DATE:	DETAILS:		INITIALS
	LOT 253 SIMMENTAL ROAD,		D	29.11.23	WORKING DRAWING REV 3		XX
$\neg$	MASON QUARTER, WOLLERT, VIC. 3750		E	15.12.23	WORKING DRAWING REV 4		XX
0		S	F	20.12.23	WORKING DRAWING REV 5		XX
_	CLIENT:	Ó	G	12.01.24	WORKING DRAWING REV 6		XX
℩	XXXX	S	Н	25.01.24	WORKING DRAWING REV 8		XX
		$\leq$	ı	29.01.24	WORKING DRAWING REV 9		XX
٩	WORKING DRAWING	R	K	02.02.24	WORKING DRAWING REV 10		XX
	WORKING DRAWING	-	L	05.02.24	WORKING DRAWING REV		XX

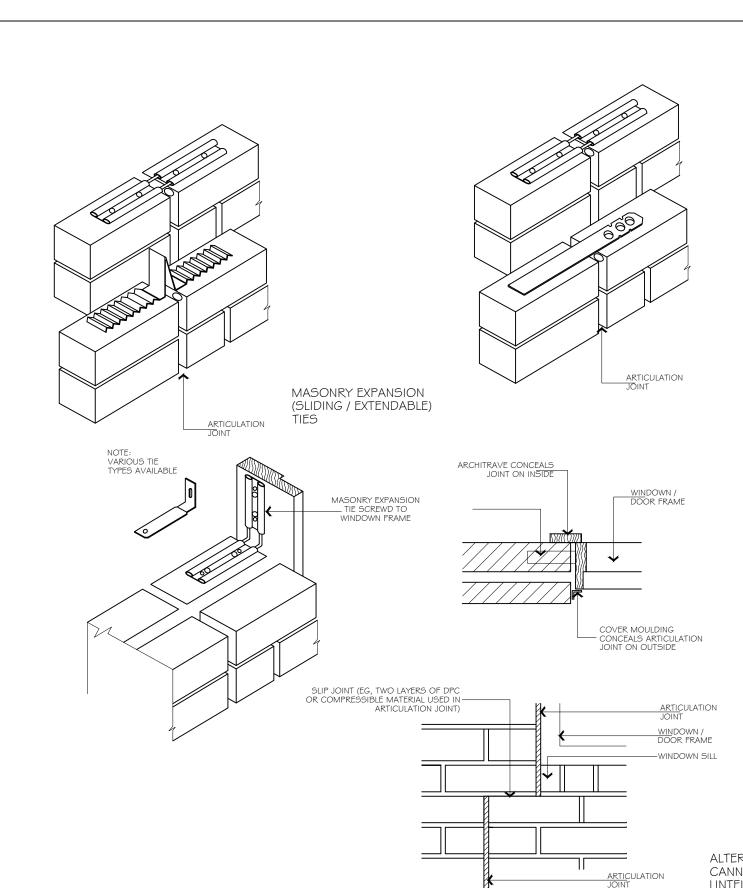


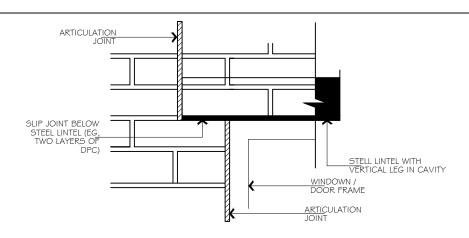

ARTICULATION JOINT OFFSET TO END OF STEEL ( OR OTHER) LINTEL OVER OPENING (THIS DETAIL IS RECOMMENDED WHERE POSSIBLE TO ENSURE ARCHING OF MASONRY OVER OPENING)

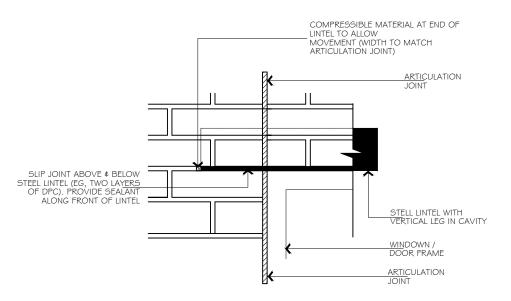

# ALTERNATIVE IF ARTICULATION JOINT CANNOT BE OFFSET TO END OF STEEL LINTEL

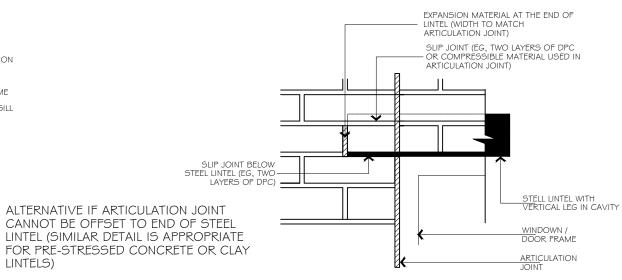

# SECTION & DETAILS

I	NOTES:
l	WRITTEN DIMENSIONS TAKE PRECEDENCE OVER SCALE. FLOOR
l	PLAN DIMENSIONS ARE TO FRAME SIZE ONLY.
l	WINDOW SIZES SHOWN ARE SUPPLIERS FRAME SIZES.
l	ALL GLAZING TO COMPLY WITH A.S. 1288-2021 & AS 2047-2014 GLASS
l	IN BUILDINGS, & WITH A.S. 4055-2012 FOR WINDLOADING.
l	WINDOW SUPPLIER TO PROVIDE COVER BOARDS TO ALL CORNER
l	WINDOWS U.N.O.
l	GARAGE ROOF TO BE TIED DOWN MIN. 1200 INTO BRICKWORK WITH
ı	HOOP IRON STRAPS

ALL WATER CLOSET DOORS TO BE REMOVABLE IN ACCORDANCE WITH PART 10.4.2 OF THE NCC 2022 VOL 2

DRAFTSPERSON; SEEMA AFTAB DP-AD 68552


LINTELS)

Τ	SHEET CONTENT:	SCALE: AS SHOWN		AS SHOWN	SHEET NUMBER: 6A OF 9	JOB NUMBER:	0001
S	SECTION & DETAILS	DAT	ΓE:	23.11.23	3 DRAWN: XX		
ш	PROPERTY ADDRESS:		ISSUE:	DATE:	DETAILS:		INITIALS:
	LOT 253 SIMMENTAL ROAD,		D	29.11.23	WORKING DRAWING REV 3		XX
$\neg$	MASON QUARTER, WOLLERT, VIC. 3750		E	15.12.23	WORKING DRAWING REV 4		XX
0		र्	F	20.12.23	WORKING DRAWING REV 5		XX
_	CLIENT:	Ó	G	12.01.24	WORKING DRAWING REV 6		XX
℩	XXXX	Š	Н	25.01.24	WORKING DRAWING REV 8		XX
		$\leq$	- 1	29.01.24	WORKING DRAWING REV 9		XX
₾	WORKING DRAWING	R	K	02.02.24	WORKING DRAWING REV 10	-	XX
	WORKING DRAWING		L	05.02.24	WORKING DRAWING REV		XX


# TYPICAL WALL AND BATH JUNCTIONS MASONRY WALL JUNCTION

# MINIMUM CHASE IN WALL TO ACCOMMADATE EDGE OF BATH WATER RESISTANT SUBSTRATE 150mm MIN, ABOVE BATH WATER RESISTANT SUBSTRATE LINING FLEXIBLE SEALANT 5-15mm WIDE FLEXIBLE SEALANT 3-5mm WIDE TRIMMER AS REQUIRED


# TYPICAL WALL WITH FIXTURES WALL AND BENCHTOP JUNCTION

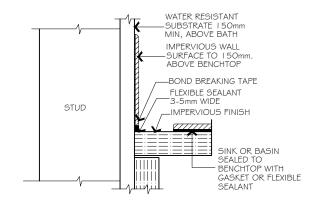


# SHOWER TRAY ON TIMBER FLOOR

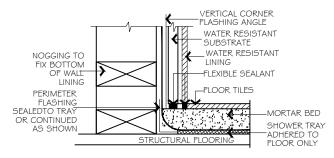


# SHOWER TRAY ON CONCRETE FLOOR

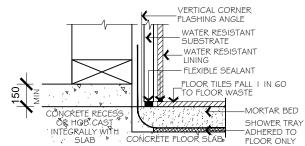


# TIMBER WALL JUCTIONS

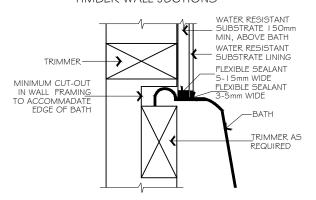


# WALL & LAUNDRY SINK JUCTIONS

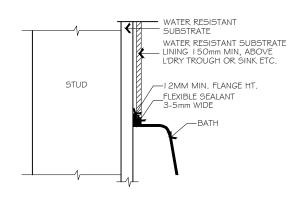


# BRICK HOB INSIDE SHOWER TRAY

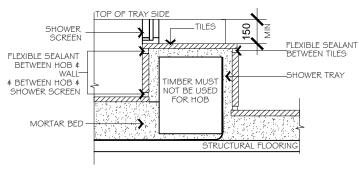

# TYPICAL INSTALLATION OF WATER PROOFING MEMBRANE TO SHOWER FLOOR

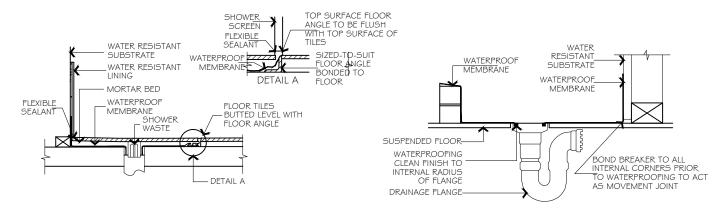

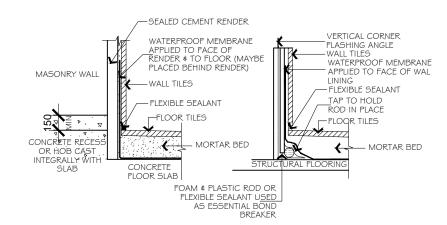


# SECTION & DETAILS

WITH PART 10.4.2 OF THE NCC 2022 VOL 2

NOTES:
WRITTEN DIMENSIONS TAKE PRECEDENCE OVER SCALE. FLOOR
PLAN DIMENSIONS ARE TO FRAME SIZE ONLY.
WINDOW SIZES SHOWN ARE SUPPLIERS FRAME SIZES.
ALL GLAZING TO COMPLY WITH A.S. 1288-2021 & AS 2047-2014 GLASS
IN BUILDINGS, & WITH A.S. 4055-2012 FOR WINDLOADING.
WINDOW SUPPLIER TO PROVIDE COVER BOARDS TO ALL CORNER
WINDOWS U.N.O.
GARAGE ROOF TO BE TIED DOWN MIN. 1200 INTO BRICKWORK WITH
HOOP IRON STRAPS.
ALL WATER CLOSET DOORS TO BE REMOVABLE IN ACCORDANCE

DRAFTSPERSON; SEEMA AFTAB DP-AD 68552

_	HEET CONTENT:		ALE: /	AS SHOWN	SHEET NUMBER: 6B of 9	JOB NUMBER:	0001
ပ	SECTION & DETAILS	DATE:		23.11.23			
ш	PROPERTY ADDRESS:		ISSUE:	DATE:	DETAILS:		INITIALS:
	LOT 253 SIMMENTAL ROAD,		D	29.11.23	WORKING DRAWING REV 3		XX
,	MASON QUARTER, WOLLERT, VIC. 3750		E	15.12.23	WORKING DRAWING REV 4		XX
0		$\bar{c}$	F	20.12.23	WORKING DRAWING REV 5		XX
_	CLIENT:	lá	G	12.01.24	WORKING DRAWING REV 6		XX
℩	XXXX	S S	Н	25.01.24	WORKING DRAWING REV 8		XX
		S	- 1	29.01.24	WORKING DRAWING REV 9		XX
ᡅ	WORKING DRAWING	R	K	02.02.24	WORKING DRAWING REV 10		XX
	WORKING DRAWING	-		05.02.24	WORKING DRAWING REV 1.1		XX

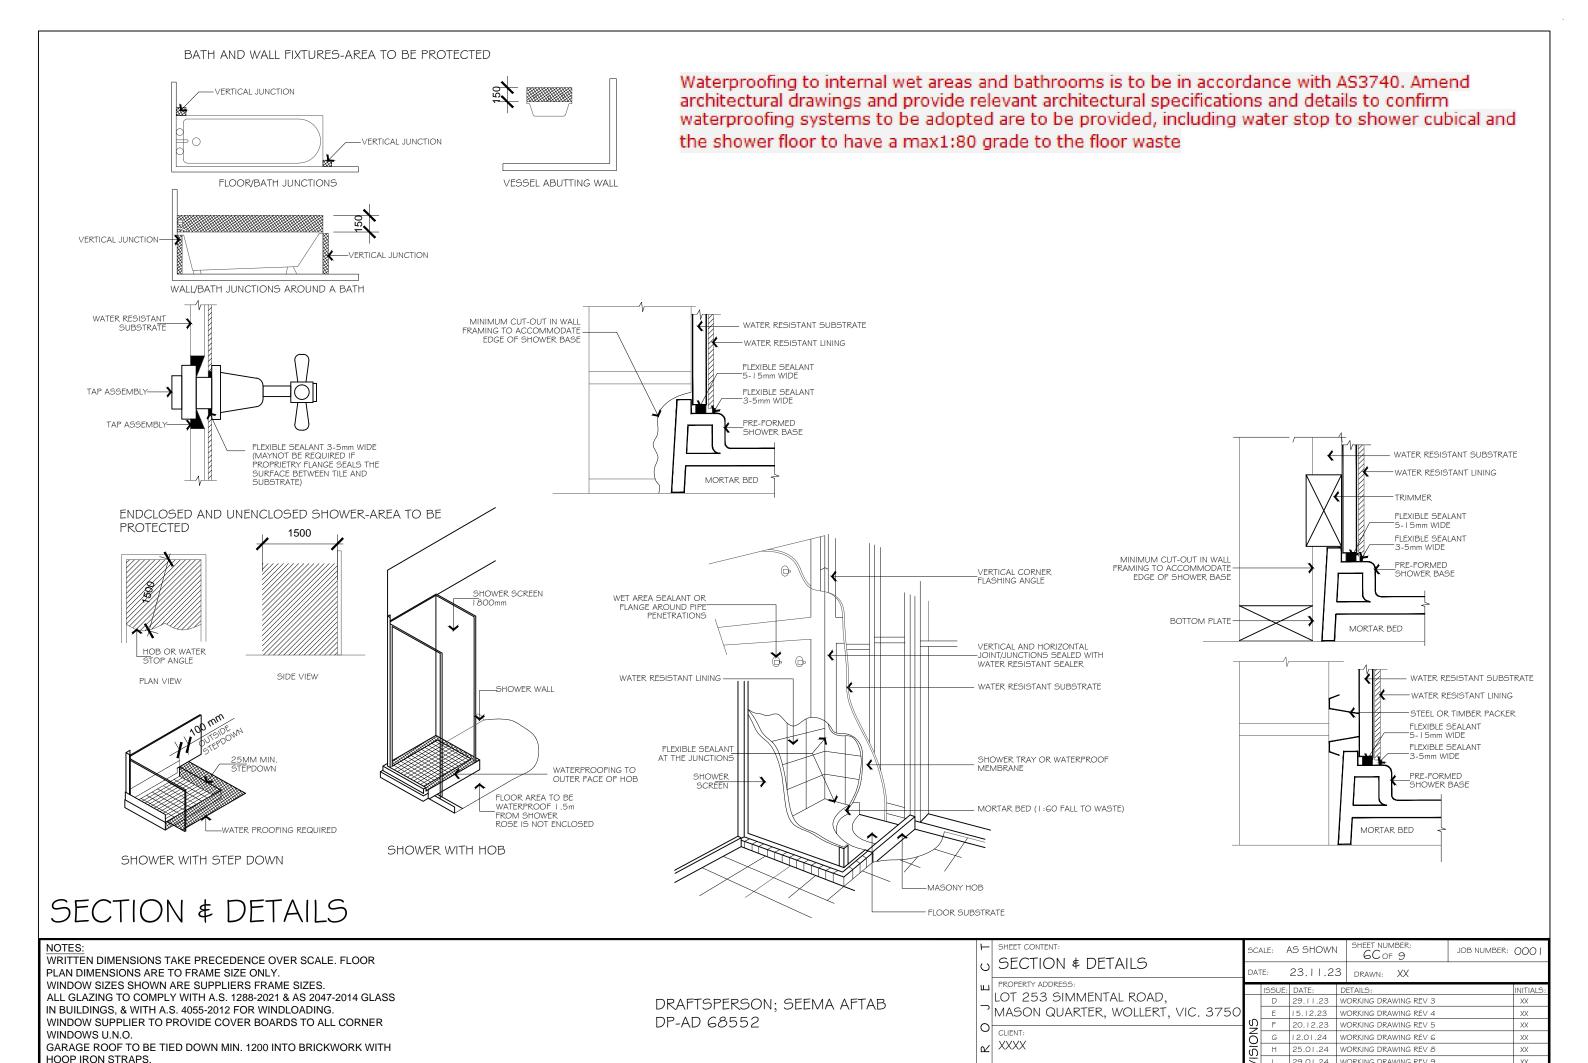

ALL WATER CLOSET DOORS TO BE REMOVABLE IN ACCORDANCE

WITH PART 10.4.2 OF THE NCC 2022 VOL 2

WORKING DRAWING REV 9

| 1 | 29.01.24 | WORKING DRAWING REV 9 | K | 02.02.24 | WORKING DRAWING REV 10

I 05 02 24 WORKING DRAWING REV LI

WORKING DRAWING

# **LEGEND**

 $\bigcirc$ STANDARD BATTEN

LED DOWNLIGHT (AS SELECTED)

CEILING EXHAUST FAN SINGLE GPO - 300mm

SINGLE GPO - I I OOmm SINGLE GPO - 1350mm

DOUBLE GPO - EXTERNAL WEATHERPROOF

EXTERNAL LIGHT POINT

SINGLE GPO - FOR M/WAVE @ 750mm(h)

SINGLE GPO - D/WASHER @ 750mm(h)  $\Re$ DOUBLE GPO - 300mm

DOUBLE GPO - I I OOmm DOUBLE GPO - 1350mm TELEVISION POINT

SMOKE DETECTOR FLOOD LIGHT - DOUBLE

WALL LIGHT BATTEN HOLDER - EXTERNAL

CEILING HEATING DUCT (APPROX LOCATION) Ė

EVAPORATIVE COOLING DUCT

THERMOSTAT POWER POINT FOR GARAGE REMOTE PANEL DOOR - LOCATE ON CEILING 3300mm FROM DOOR OPENING LINTEL \$ 200mm OFF DOOR CENTRE.

TP TERMINATION POINT TELEPHONE POINT

RA RETURN AIR D DATA POINT

DUCTED HEATING UNIT LOCATION

МН ROOF ACCESS

DB DOOR BELL

AB ACP ALARM SYSTEM (WITH 3 SENSORS)

ALARM SENSOR  $\triangleleft$ 

INT AUDIO VIDEO INTERCOM PART 13.7.6 OF NCC 2022 VOL 2 ARTIFICIAL LIGHTING LAMP POWER DENSITY SHALL NOT EXCEED:

5W/sq.m FOR CLASS 1 BUILDING

4W/sq.m FOR VERANDAH, ALFRESCO, PORCH OR BALCONY 3W/sq.m FOR CLASS 10a BUILDING PERIMETER LIGHTING TO BE CONTROLLED BY A SENSOR OR HAVE A MAXIMUM OF 40 LUMENS PER WATT.

SMOKE DETECTORS TO BE INTERCONNECTED AS PER NCC 2022

ARTIFICIAL LIGHTING WATTAGE										
ROOM	AREA (m²)	WAT	WABLE TAGE (m²)	ALLOW A	TOTAL ALLOWABLE WATTAGE		CURRENT TOTAL WATTAGE		CURRENT WATTAGE PER (m²)	
PORCH/ALFRESCO	6.93	4	W/m²	27.72	W	10	W	1.44	W/m²	
GARAGE	23.59	3	W/m²	70.77	W	11	W	0.47	W/m²	
GROUND	150.62	5	W/m²	753.10	W	323	W	2.14	W/m²	
TOTAL	181.14				W	344	W	1.90	W/m²	

SMOKE DETECTORS:

SMOKE DETECTORS TO BE INSTALLED IN ACCORDANCE WITH AS 3786-2014. LOCATE A MIN 300mm FROM VALLS \$ DOORWAYS \$ BE HARDWIRED \$ NTERCONNECTED THROUGHOUT THE DWELLING

NOTE:

ALL LIGHT SWITCHES ARE LOCATED 1050MM FROM FLOOR LEVEL UNLESS NOTTED OTHERWISE.

PROVIDE EXHAUST FANS RANGEHOOD ETC, ARE TO VENT TO THE OUTSIDE ATMOSPHERE.

NOTE:

HEATING & COOLING OUTLET LOCATIONS ARE IN APPROXIMATE POSITIONS ONLY & ARE SUBJECT TO VERIFICATION BY HEATING CONTRACTOR.

ALL MECHANICAL VENTILATION MUST BE DISCHARGED TO THE OUTSIDE.

NOTE: THIS IS NBN ESTATE: ONT CONNECTION REQUIRED -BY OTHERS


PROVIDE SINGLE GPO AND BATTEN LIGHT TO ROOF SPACE - CLOSE TO MANHOLE

SMOKE DETECTORS: SMOKE ALARMS ARE TO BE PROVIDED WITH A BATTERY BACK-UP AND TO BE HARDWIRED IN ACCORDANCE WITH NCC PART 9.5 OF THE NCC 2022 VOL 2

# EXHAUST FAN FLOW RATES AS PER CLAUSE 10.8.2 OF NCC 2022 VOL 2 BATHROOM OR SANITARY COMPARTMENT -25L/ KITCHEN OR L'DRY - 40L/s

PROVIDE EXHAUST FANS, RANGEHOOD ETC, ARE TO VENT TO THE OUTSIDE ATMOSPHERE THROUGH ROOF VIA WHIRLY BIRD OF NCC 2022 VOL 2

MOKE ALARMS TO ALL BED OOMS & CORRIDOR IN ACCORDANCE WITH PART 9.5

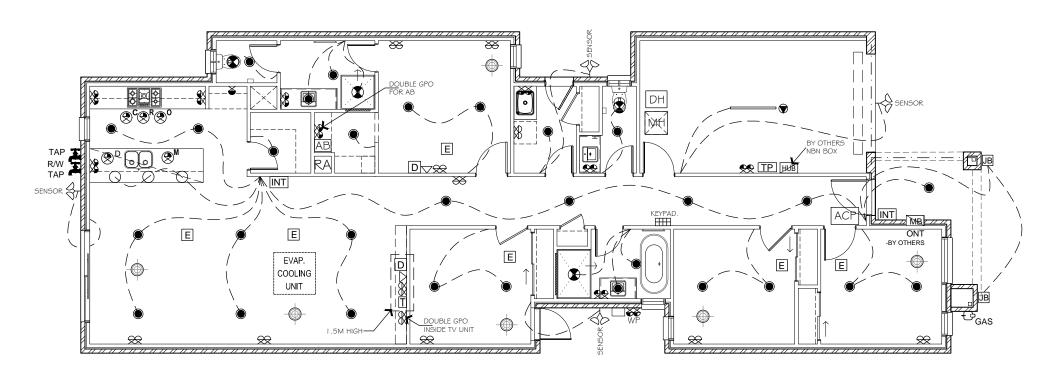

# ELECTRICAL PLAN

NOTES:

WRITTEN DIMENSIONS TAKE PRECEDENCE OVER SCALE. FLOOR PLAN DIMENSIONS ARE TO FRAME SIZE ONLY.

WINDOW SIZES SHOWN ARE SUPPLIERS FRAME SIZES. ALL GLAZING TO COMPLY WITH A.S. 1288-2021 & AS 2047-2014 GLASS

IN BUILDINGS, & WITH A.S. 4055-2012 FOR WINDLOADING. WINDOW SUPPLIER TO PROVIDE COVER BOARDS TO ALL CORNER WINDOWS U.N.O.

GARAGE ROOF TO BE TIED DOWN MIN. 1200 INTO BRICKWORK WITH HOOP IRON STRAPS.

ALL WATER CLOSET DOORS TO BE REMOVABLE IN ACCORDANCE WITH PART 10.4.2 OF THE NCC 2022 VOL 2

DRAFTSPERSON; SEEMA AFTAB DP-AD 68552

	<b>—</b>			ALE:	1:100	7 of 9	JOB NUMBER:	0001
	S	ELECTRICAL PLAN	DAT	ΓE:	23.11.23	3 DRAWN: XX		
	ш	PROPERTY ADDRESS: LOT 253 SIMMENTAL ROAD, MASON QUARTER, WOLLERT, VIC. 3750		ISSUE:	DATE:	DETAILS:		INITIALS:
				D	29.11.23	WORKING DRAWING REV 3		XX
	$\neg$		S	E	15.12.23	WORKING DRAWING REV 4		XX
	O			F	20.12.23	WORKING DRAWING REV 5		XX
		CLIENT:	ń	G	12.01.24	WORKING DRAWING REV 6		XX
	℩		VISI	Н	25.01.24	WORKING DRAWING REV 8		XX
				- 1	29.01.24	WORKING DRAWING REV 9		XX
Δ.	1	WORKING DRAWING	RE	K	02.02.24	WORKING DRAWING REV 10		XX
				L	05.02.24	WORKING DRAWING REV		XX

SIDE ,REAR \$ WING FENCE TO BE CONSTRUCTED AS PER DEVELOPERS GUIDELINES REQUIREMENTS \$ COMPLETED BY BUILDER



DRIVEWAY & FRONT PATH TO BE CONSTRUCTED OF EXPOSED AGGREGATE DRIVEWAY TO BE COMPLETED BY BUILDER & TO COMPLY WITH RELEVANT DESIGN GUIDELINES.

# LANDSCAPE



DENOTES PLAIN CONCRETE



DENOTES COLOURED CONCRETE



DENOTES DROUGHT TOLERANT PLANTS AND MULCH



DENOTES EXPOSED AGGREGATE

# PLANT SCHEDULE



PHORMIUM 'GREEN' PROPOSED GROUND COVER (150 pot size) -20 NO.



WESTRINGIA FRUTICOSA (150mm POT SIZE) - 20 NO.



LITTLE GEM MAGNOLIA (2.0m TALL) - 2 NO.




BANKSIA "BIRTHDAY CANDLES" (200 POT SIZE) - 10 NO.

CONCRETE LETTER
BOX



LETTER BOX



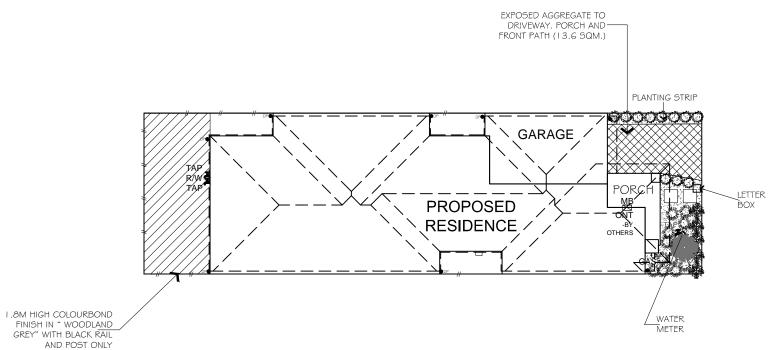

# LANDSCAPE PLAN (BY CLIENTS AFTER HAND OVER)

# NOTES:

WRITTEN DIMENSIONS TAKE PRECEDENCE OVER SCALE. FLOOR PLAN DIMENSIONS ARE TO FRAME SIZE ONLY.
WINDOW SIZES SHOWN ARE SUPPLIERS FRAME SIZES.
ALL GLAZING TO COMPLY WITH A.S. 1288-2021 & AS 2047-2014 GLASS IN BUILDINGS, & WITH A.S. 4055-2012 FOR WINDLOADING.
WINDOW SUPPLIER TO PROVIDE COVER BOARDS TO ALL CORNER WINDOWS U.N.O.

GARAGE ROOF TO BE TIED DOWN MIN. 1200 INTO BRICKWORK WITH HOOP IRON STRAPS.

ALL WATER CLOSET DOORS TO BE REMOVABLE IN ACCORDANCE WITH PART 10.4.2 OF THE NCC 2022 VOL 2

DRAFTSPERSON; SEEMA AFTAB DP-AD 68552

LANDSCAPE

PROPERTY ADDRESS:
LOT 253 SIMMENTAL ROAD,
MASON QUARTER, WOLLERT, VIC. 3750

CLIENT:
XXXX

► SHEET CONTENT:

WORKING DRAWING

DAT	E:	23.11.23	3 drawn: XX						
	ISSUE:	DATE:	DETAILS:	INITIALS:					
	D	29.11.23	WORKING DRAWING REV 3	XX					
	E	15.12.23	WORKING DRAWING REV 4 XX						
छ	F	20.12.23	WORKING DRAWING REV 5	XX					
REVISIONS	G	12.01.24	WORKING DRAWING REV 6	XX					
$\tilde{\sigma}$	Н	25.01.24	WORKING DRAWING REV 8	XX					
Š	- 1	29.01.24	WORKING DRAWING REV 9	XX					
W.	K	02.02.24	WORKING DRAWING REV 10	XX					
~	-	05 02 24	WORKING DRAWING REV. L.I.	VV					

JOB NUMBER: OOO I

HEET NUMBER:

